



FY23 Public Art Building Communities Grantee:

Southwest Business Improvement District "GALLERY OF SOUTHWEST: CELEBRATING THE PAST, PRESENT, AND FUTURE"

CFA Review Meeting: November 17, 2022

Submission Date: November 3, 2022





Grantee: Southwest Business Improvement District

Project Name: GALLERY OF SOUTHWEST: CELEBRATING THE PAST, PRESENT, AND FUTURE

Artist(s): Chelsea Ritter-Soronen, Juan Pineda aka CRI, David Carmack Lewis, Ham

and Cheese, Jarrett Ferrier, Jesse Kirsch, Kaliq N Crosby aka KaliQ, Luther Wright, Sasha Reisin aka Primo, (Rodrigo Pradel, Michael Pacheco, Monica

Tucker-Harley, Sarah Berry aka RoMiMoSa) and Rose Jaffe

Where: 500-600 4th Street SW 20024 - 395 underpass

Ward: 6

Type: Permanent

Twelve 12 murals painted in upper portion of underpass beneath I-395.

Located in the underpass beneath I-395, this project will serve as a cultural portal that will physically reconnect two portions of Southwest severed by the interstate more than 50 years ago. The subtle indentations that currently line the underpass walls will be transformed into a gallery that heralds the Southwest community's culture, resurfaces its history and shares its joy with those passing through.

As designed, this project will bring commissioned street art to adorn the underbelly of the 4th Street SW underpass. The art reflects the history, culture, people, and future of Southwest DC from the perspective of 11 different artist groups in the form of 12 unique, high-quality murals. The power of the artists' thoughtful concepts and brush of brilliance will be included in a QR code that will link to the SWBID website providing more detailed background and descriptions.



Southwest Washington DC

An Arts and Cultural Destination





CONCEPT | ARTS AND CULTURAL DESTINATION

VISION: Southwest will flourish as a premier arts and cultural destination, creating synergies between existing cultural assets and attracting new creative uses and arts-related activities.

ACTIC	on .	GUIDING PRINCIPLES ADDRESSED	TIMELINE	LEAD AGENCY	PARTNER AGENCY
AC.1	Foster the Southwest neighborhood arts hub by expanding events, such as Jazz Night at Westminster, Southwest Night at Arena Stage, activities with Blind Whino, and future events with the proposed Rubell Museum at the Randall School.	б	Short Term	SW BID	Southwest Arts Organizations
AC.2	Promote the arts as a community amenity in neighborhood marketing materials and communicate current and planned activities involving the arts to residents throughout the District of Columbia. Develop a single source to advertise and promote all arts events in one place for easier access and more effective marketing.	6	Short to Mid Term	SW BID	DCOP
AC.3	Renovate the Randall Recreation Center to support both recreation and multi- purpose arts focused programming while maintaining existing playing fields and greenspaces.	5, 6	Mid Term	SW BID	ANC
AC.4	Market the required affordable units in the new Randall School development to artists who meet the affordability requirements.	6, 7	Short to Mid Term	Randall School Development Team	DCHA
AC.5	Encourage the creation of incubator space for local arts organizations or other creative entrepreneurs (e.g., web designers, film editing, production, culinary space, etc.) or local business start-ups on the ground floors of new buildings on M and 'I' Streets.	4, 6	Long Term	DMPED, WDCEP	DCOP
AC.6	Initiate a pilot improvement project for at least one underpass to include unique public art and lighting.	3,6	Short Term	DCOP	DCCAH, Underpass Owner
AC.7	Support the use grants, pilot programming or public/private partnerships to help fund "pop-up" programming, short-term events and other efforts by the Neighbors of the Southwest Duck Pond to expand activities in this location.	5,6	Short to Mid Term	DCOP	Community Groups, Southwest Duck Pond

Arts in the Public Realm. The Southwest neighborhood can reinforce its identity as an arts and culture destination by manifesting the arts in the public realm. Temporary installations, "pop-up" programming, and events can be focused around the Southwest Duck Pond and vacant parcels and retail spaces along 4th Street SW. Underpasses have long stood as a neighborhood barrier that may be significantly enhanced through incorporation of public art and lighting.

Reclaimed Connections. Urban Renewal and the Modernist designs that followed it left an indelible mark on the block structure of Southwest, which many residents appreciate for the internalized residential communities it forged. However, the restoration of the L'Enfant street grid in strategic locations that do not impact existing residences will enhance the mobility and ease of walking through the neighborhood. In particular, the government-owned parcels around Lansburgh Park offer the opportunity to restore mapped streets when redeveloped in the future. These streets will also bring additional activity and visibility to a now "hidden" park asset. Southwest can also tackle the unpleasant experience of traversing underpasses of the I-395 and CSX rights of way by ensuring appropriate lighting and regular maintenance and cleaning, as well as piloting public art interventions.



Southwest Washington DC

Site Context





Southwest Washington DC

M

Residential

Commercial

Site Context



Federal Public

Local Public


Median

Undetermined

Transportation Right of Way




Existing Conditions

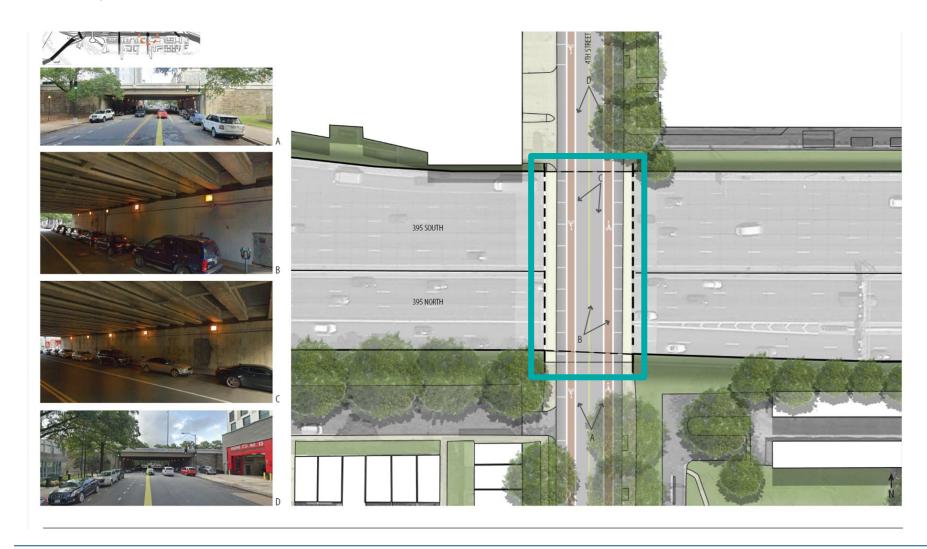



Existing Conditions




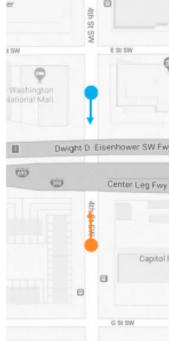




Modalities of Movement



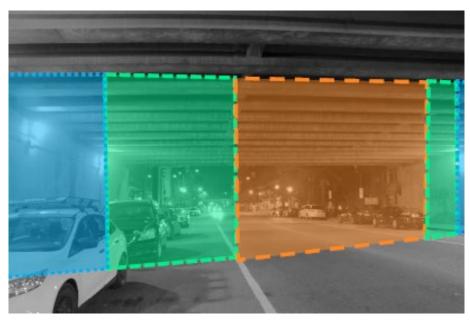



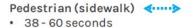



Bicycle (bicycle lane) <-->
• 8 - 10 seconds





Vehicle (driving lane) <->
• 4-5 seconds




SWBID

Connecting Portals

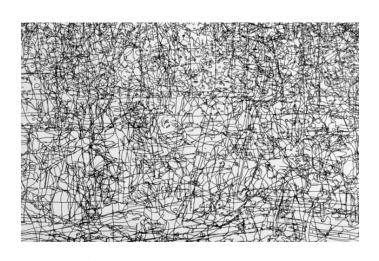

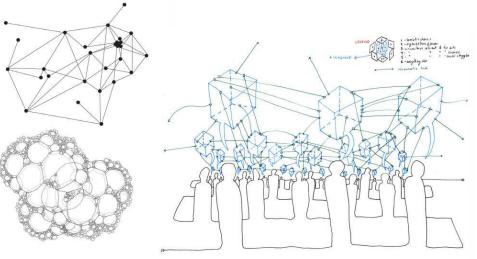




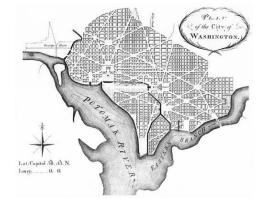



Art Portal - Illumination (with concept art)

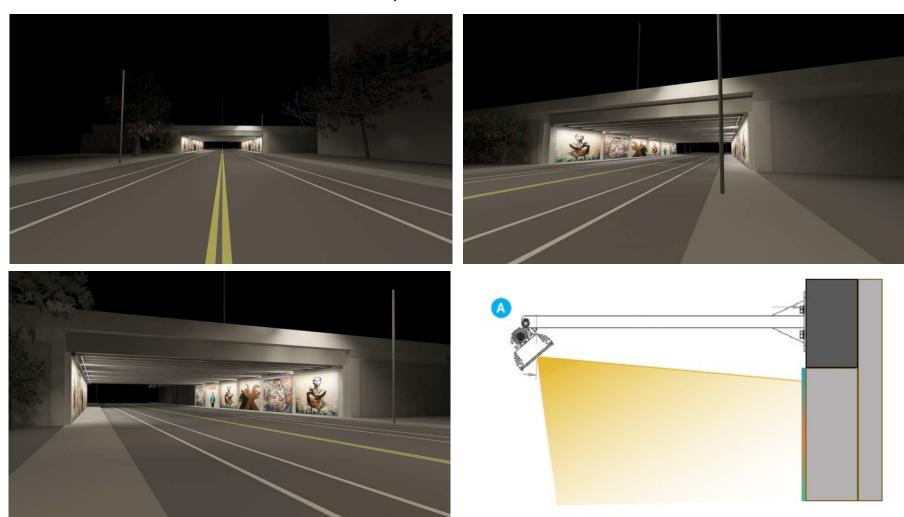




Art Portal - Illumination

No Art Lighting (Concept Art)



With Art Lighting (Concept Art)




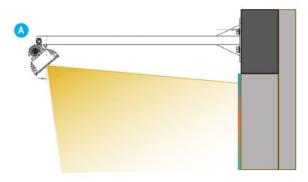








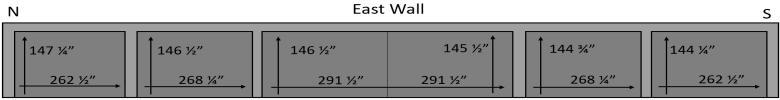

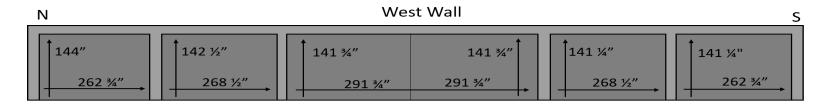




Art Portal - Gallery of Southwest: Celebrating the Past, Present, & Future Final Artwork




East Wall






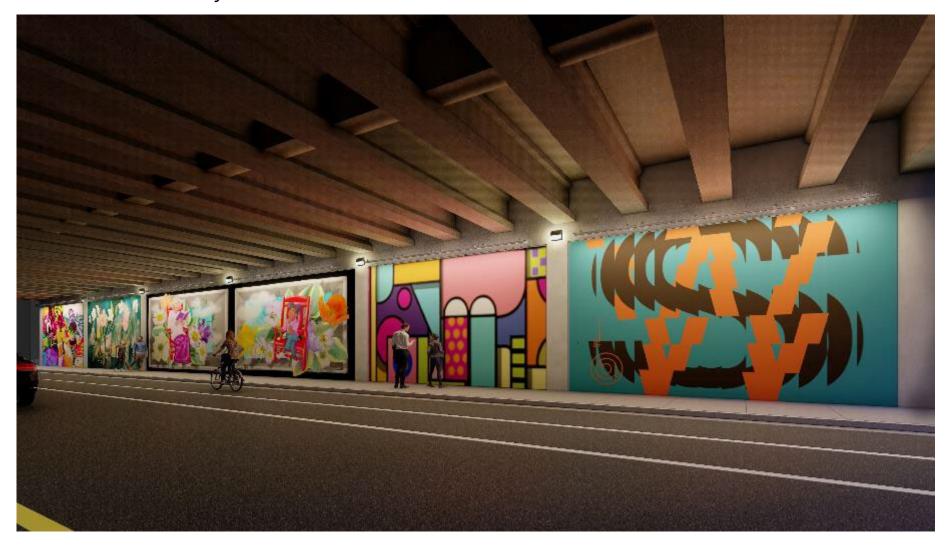




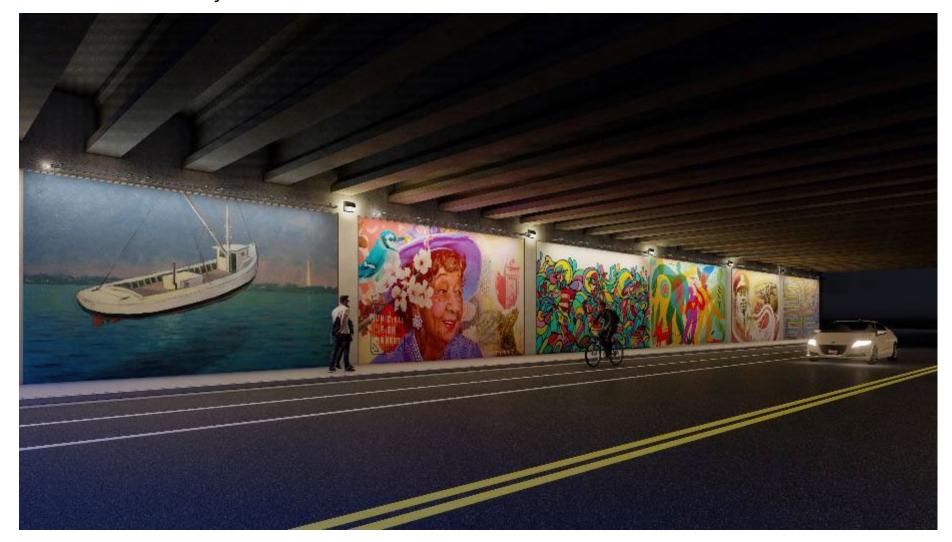



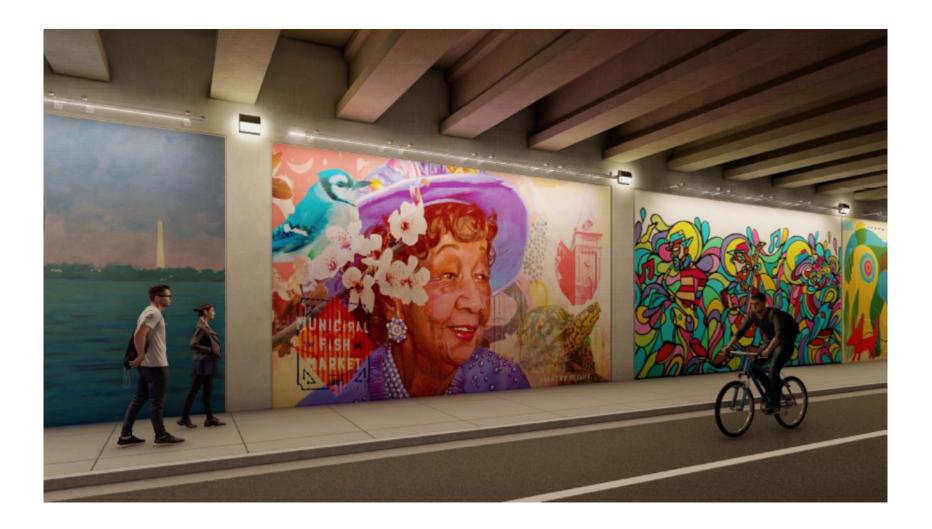



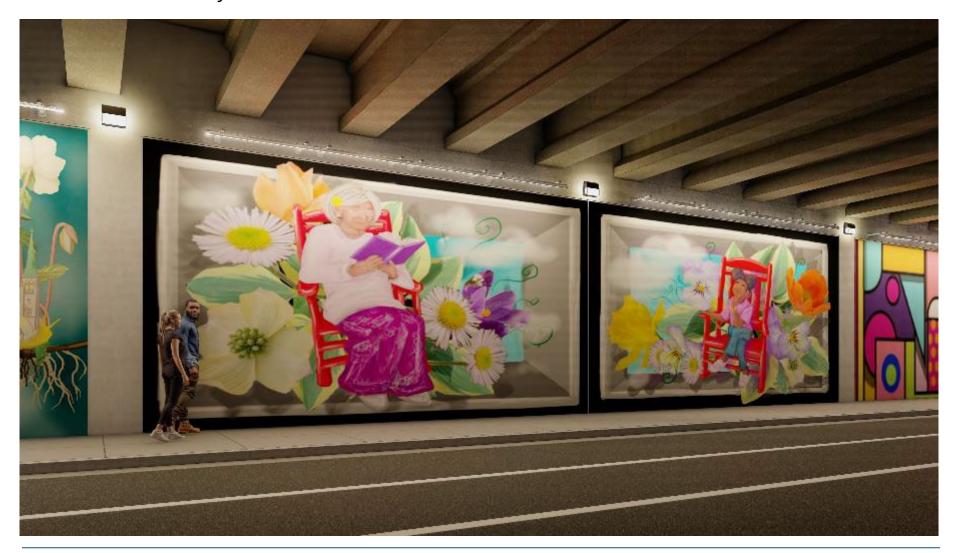



Gallery of Southwest

Artwork Selection Process

Request for Qualifications

- 46 responses
- Worldwide applications
- Criteria
 - Letter of intent
 - Artistic content
 - Capacity understanding of project & previous experience

Request for Proposals

- 15 applications
- Criteria
 - Artistic content
 - Connection to community
 - Capacity
- Looked for diversity in designs and artists


Finalists

- 11 artists
 - 5 DC-based artists
 - 4 within 20 miles of DC





JARRETT FARRIER

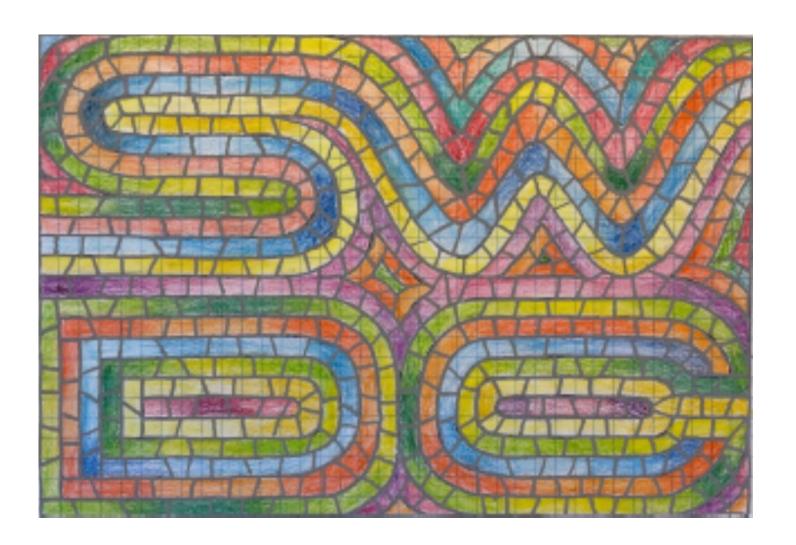





KALIQ

Southwest Soldier







ROSE JAFFE





LUTHER WRIGHT







SASHA REISIN AKA PRIMO








DAVID CARMACK LEWIS

Deadrise

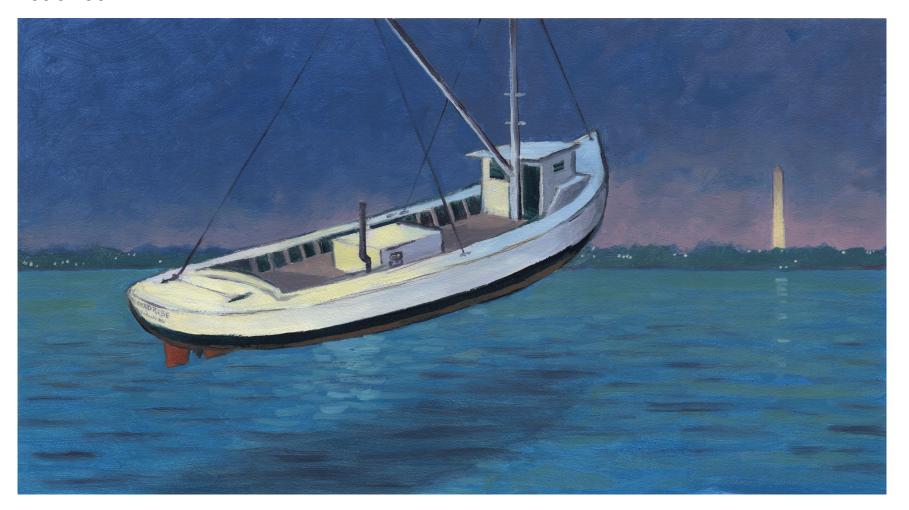





JESSE KIRSH AKA NO PRESS PLAN





CRIOMATIC





CHELSEA RITTER-SORONEN









HAM AND CHEESE STUDIO







RIMIMOSA

PRESENT & FUTURE: Culture, Play, and Preservation








THANK YOU!



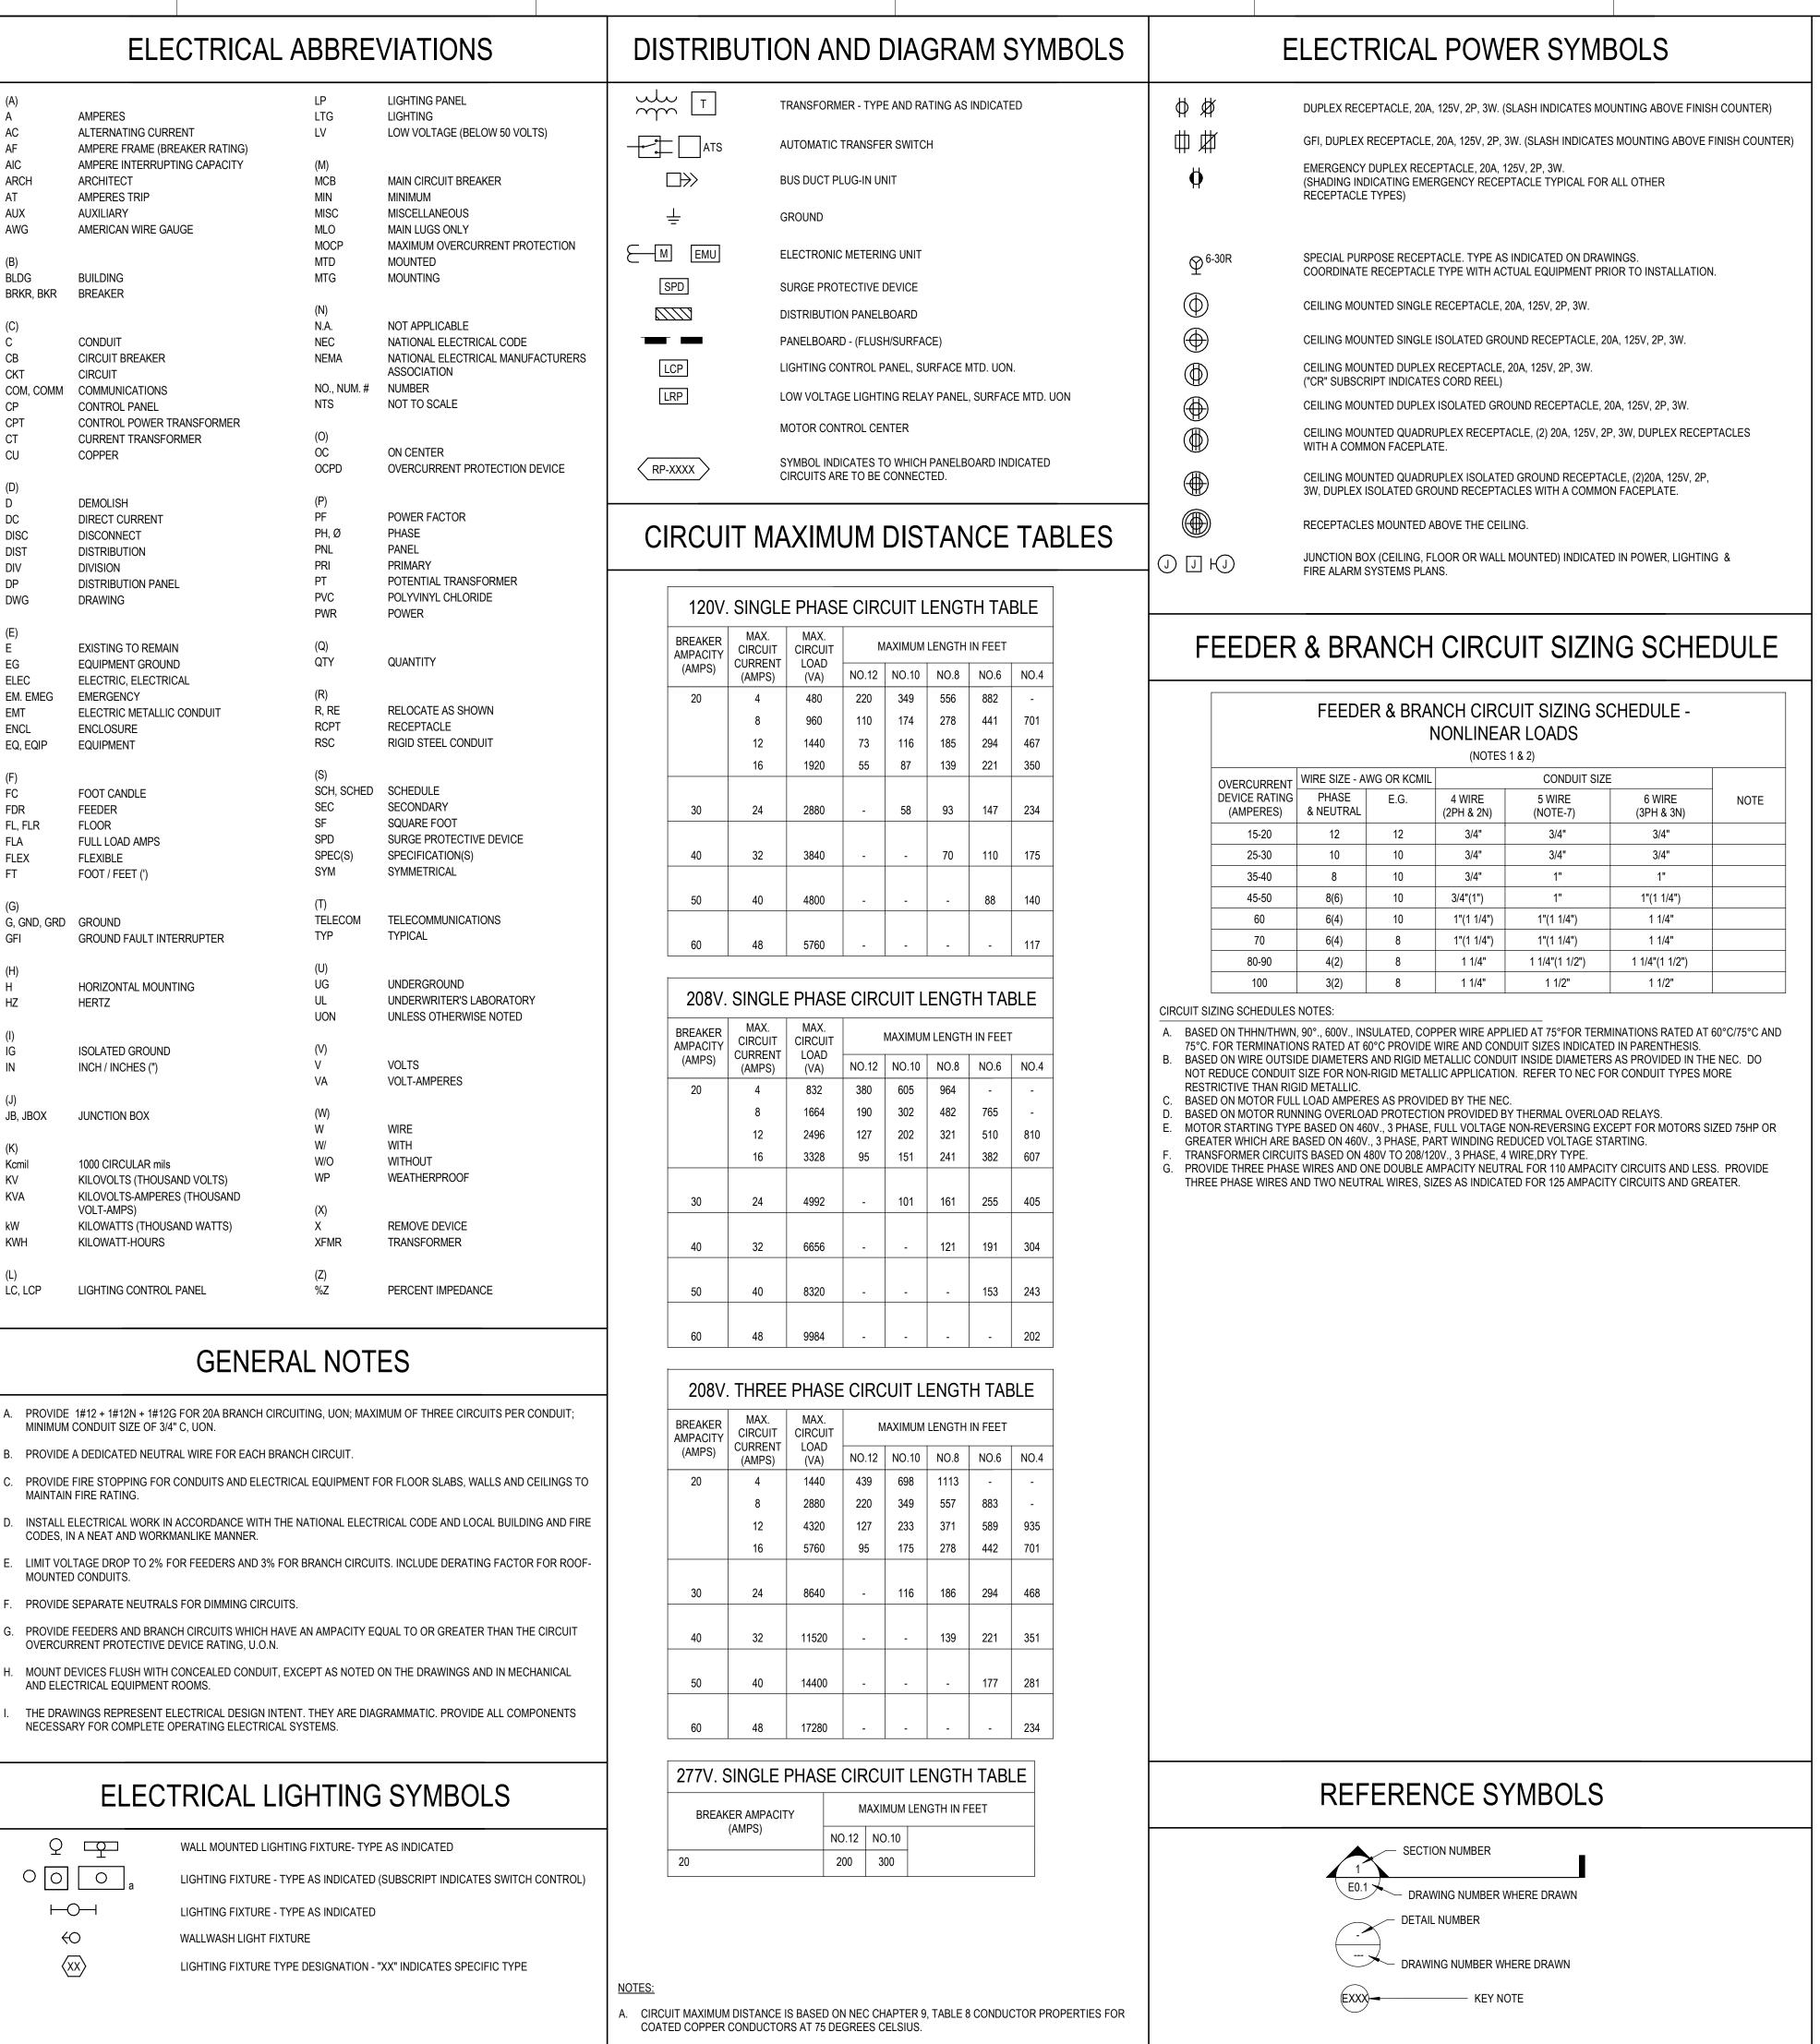

SW DC BRIDGE/UNDERPASS **LIGHTING PROJECT**

4TH AND E ST. SW. WASHINGTON, D.C. 20024

SMITHGROUP

500 GRISWOLD **SUITE 1700** DETROIT, MI 48226 313.983.3600 smithgroup.com

1700 NEW YORK AVENUE NW SUITE 100 WASHINGTON, DC 20006 202.842.2100 smithgroup.com

ISSUED FOR	REV	DATE
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CFA REVISION	2	2022 1104

2021 0806

SEALS AND SIGNATURES


100% CONSTRUCTION DOCUMENTS



SHEET TITLE

ELECTRICAL ABBREVIATIONS AND **SYMBOLS**

PROJECT NUMBER

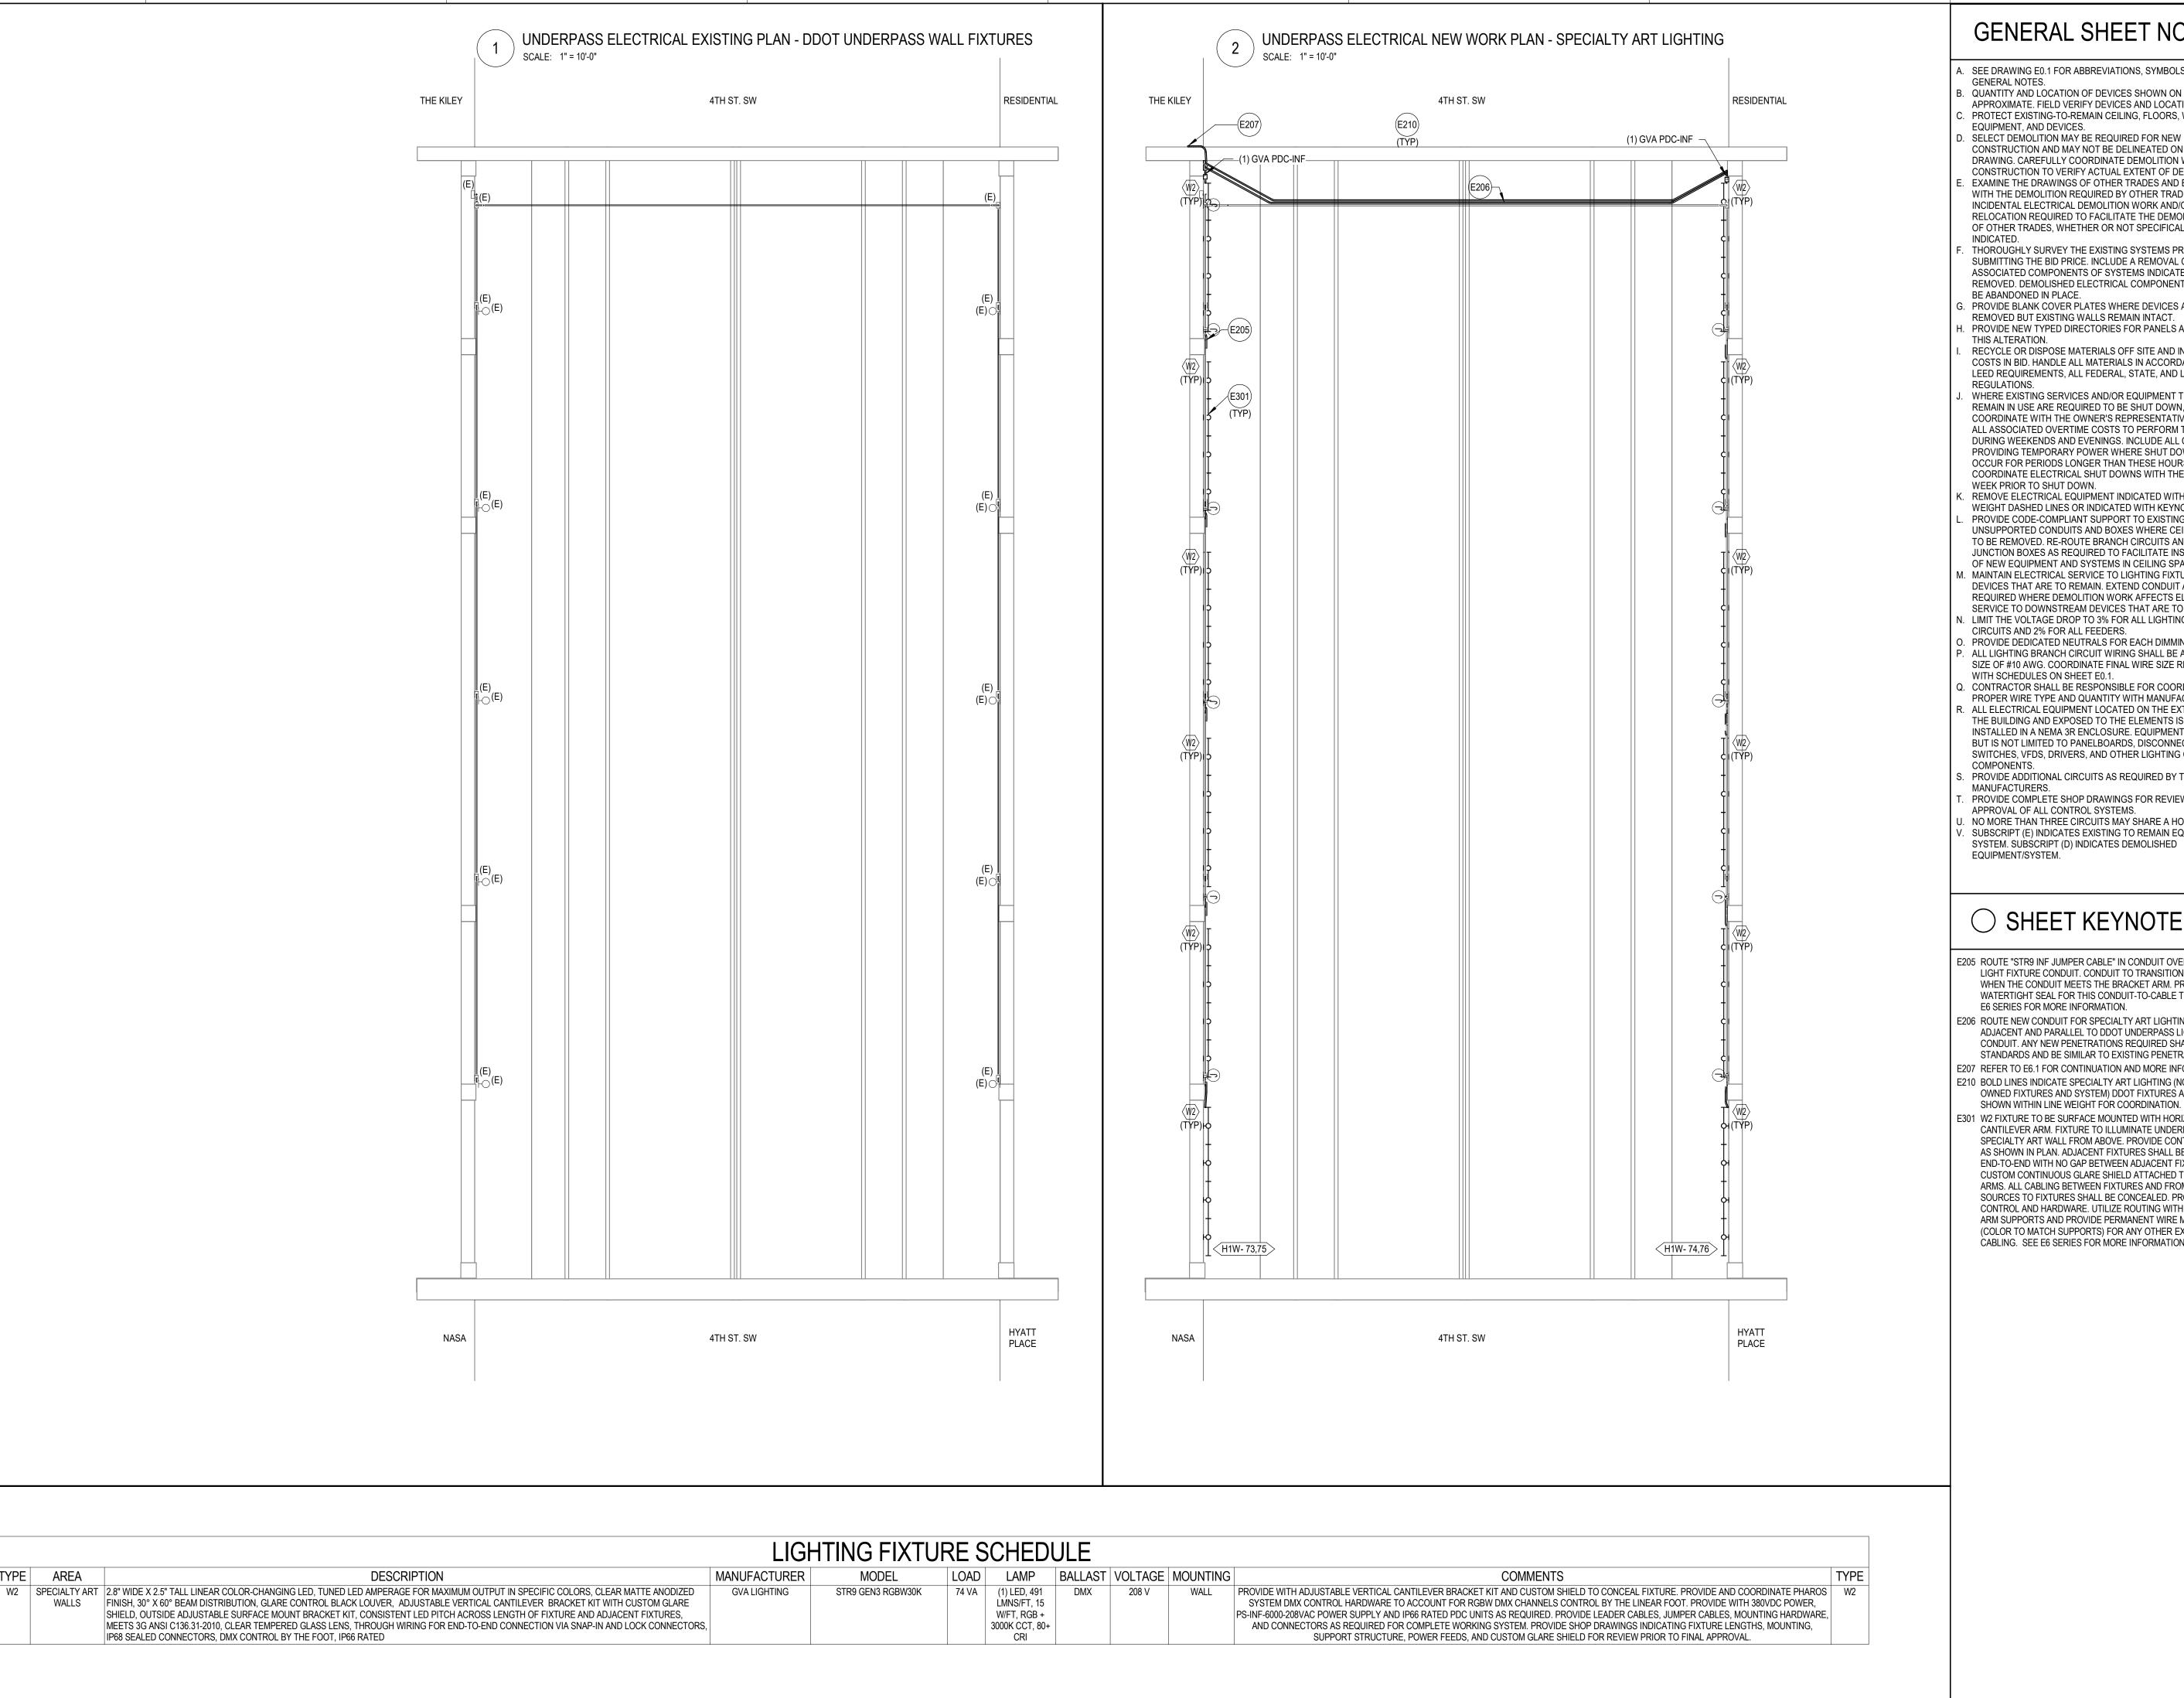

GENERAL SHEET NOTES

- SEE DRAWING E0.1 FOR ABBREVIATIONS, SYMBOLS, AND
- QUANTITY AND LOCATION OF DEVICES SHOWN ON PLANS ARE APPROXIMATE. FIELD VERIFY DEVICES AND LOCATIONS.
- PROTECT EXISTING-TO-REMAIN CEILING, FLOORS, WALLS, EQUIPMENT, AND DEVICES.
- SELECT DEMOLITION MAY BE REQUIRED FOR NEW CONSTRUCTION AND MAY NOT BE DELINEATED ON THIS DRAWING. CAREFULLY COORDINATE DEMOLITION WITH NEW CONSTRUCTION TO VERIFY ACTUAL EXTENT OF DEMOLITION.
- EXAMINE THE DRAWINGS OF OTHER TRADES AND BE FAMILIAR WITH THE DEMOLITION REQUIRED BY OTHER TRADES. PERFORM INCIDENTAL ELECTRICAL DEMOLITION WORK AND/OR RELOCATION REQUIRED TO FACILITATE THE DEMOLITION WORK OF OTHER TRADES, WHETHER OR NOT SPECIFICALLY
- THOROUGHLY SURVEY THE EXISTING SYSTEMS PRIOR TO SUBMITTING THE BID PRICE. INCLUDE A REMOVAL OF ALL ASSOCIATED COMPONENTS OF SYSTEMS INDICATED TO BE REMOVED. DEMOLISHED ELECTRICAL COMPONENTS SHALL NOT
- BE ABANDONED IN PLACE. PROVIDE BLANK COVER PLATES WHERE DEVICES ARE REMOVED BUT EXISTING WALLS REMAIN INTACT.
- PROVIDE NEW TYPED DIRECTORIES FOR PANELS AFFECTED BY THIS ALTERATION. RECYCLE OR DISPOSE MATERIALS OFF SITE AND INCLUDE ALL COSTS IN BID. HANDLE ALL MATERIALS IN ACCORDANCE WITH LEED REQUIREMENTS, ALL FEDERAL, STATE, AND LOCAL
- WHERE EXISTING SERVICES AND/OR EQUIPMENT THAT IS TO REMAIN IN USE ARE REQUIRED TO BE SHUT DOWN, COORDINATE WITH THE OWNER'S REPRESENTATIVE. INCLUDE ALL ASSOCIATED OVERTIME COSTS TO PERFORM THIS WORK DURING WEEKENDS AND EVENINGS. INCLUDE ALL COSTS FOR PROVIDING TEMPORARY POWER WHERE SHUT DOWN MUST OCCUR FOR PERIODS LONGER THAN THESE HOURS. COORDINATE ELECTRICAL SHUT DOWNS WITH THE OWNER ONE
- REMOVE ELECTRICAL EQUIPMENT INDICATED WITH HEAVY WEIGHT DASHED LINES OR INDICATED WITH KEYNOTES. PROVIDE CODE-COMPLIANT SUPPORT TO EXISTING-TO-REMAIN UNSUPPORTED CONDUITS AND BOXES WHERE CEILINGS ARE TO BE REMOVED. RE-ROUTE BRANCH CIRCUITS AND RELOCATE JUNCTION BOXES AS REQUIRED TO FACILITATE INSTALLATION
- OF NEW EQUIPMENT AND SYSTEMS IN CEILING SPACES. MAINTAIN ELECTRICAL SERVICE TO LIGHTING FIXTURES AND DEVICES THAT ARE TO REMAIN. EXTEND CONDUIT AND WIRE AS REQUIRED WHERE DEMOLITION WORK AFFECTS ELECTRICAL SERVICE TO DOWNSTREAM DEVICES THAT ARE TO REMAIN. LIMIT THE VOLTAGE DROP TO 3% FOR ALL LIGHTING BRANCH CIRCUITS AND 2% FOR ALL FEEDERS.
- PROVIDE DEDICATED NEUTRALS FOR EACH DIMMING CIRCUIT. ALL LIGHTING BRANCH CIRCUIT WIRING SHALL BE A MINIMUM SIZE OF #10 AWG. COORDINATE FINAL WIRE SIZE REQUIRED WITH SCHEDULES ON SHEET E0.1.
- CONTRACTOR SHALL BE RESPONSIBLE FOR COORDINATING PROPER WIRE TYPE AND QUANTITY WITH MANUFACTURER. ALL ELECTRICAL EQUIPMENT LOCATED ON THE EXTERIOR OF THE BUILDING AND EXPOSED TO THE ELEMENTS IS TO BE INSTALLED IN A NEMA 3R ENCLOSURE. EQUIPMENT INCLUDES BUT IS NOT LIMITED TO PANELBOARDS, DISCONNECT SWITCHES, VFDS, DRIVERS, AND OTHER LIGHTING CONTROL
- PROVIDE ADDITIONAL CIRCUITS AS REQUIRED BY THE
- MANUFACTURERS. PROVIDE COMPLETE SHOP DRAWINGS FOR REVIEW AND
- APPROVAL OF ALL CONTROL SYSTEMS. NO MORE THAN THREE CIRCUITS MAY SHARE A HOMERUN. SUBSCRIPT (E) INDICATES EXISTING TO REMAIN EQUIPMENT /
- EQUIPMENT/SYSTEM.

SHEET KEYNOTES

- E205 ROUTE "STR9 INF JUMPER CABLE" IN CONDUIT OVER THE DDOT LIGHT FIXTURE CONDUIT. CONDUIT TO TRANSITION TO CABLING WHEN THE CONDUIT MEETS THE BRACKET ARM. PROVIDE WATERTIGHT SEAL FOR THIS CONDUIT-TO-CABLE TRANSITION. SEE E6 SERIES FOR MORE INFORMATION.
- E206 ROUTE NEW CONDUIT FOR SPECIALTY ART LIGHTING DIRECTLY ADJACENT AND PARALLEL TO DDOT UNDERPASS LIGHTING CONDUIT. ANY NEW PENETRATIONS REQUIRED SHALL MEET DDOT STANDARDS AND BE SIMILAR TO EXISTING PENETRATIONS.
- E207 REFER TO E6.1 FOR CONTINUATION AND MORE INFORMATION. E210 BOLD LINES INDICATE SPECIALTY ART LIGHTING (NON-DDOT OWNED FIXTURES AND SYSTEM) DDOT FIXTURES AND SYSTEM SHOWN WITHIN LINE WEIGHT FOR COORDINATION.
- E301 W2 FIXTURE TO BE SURFACE MOUNTED WITH HORIZONTAL CANTILEVER ARM. FIXTURE TO ILLUMINATE UNDERPASS SPECIALTY ART WALL FROM ABOVE, PROVIDE CONTINUOUS RUN AS SHOWN IN PLAN. ADJACENT FIXTURES SHALL BE INSTALLED END-TO-END WITH NO GAP BETWEEN ADJACENT FIXTURES. CUSTOM CONTINUOUS GLARE SHIELD ATTACHED TO MOUNTING ARMS. ALL CABLING BETWEEN FIXTURES AND FROM POWER SOURCES TO FIXTURES SHALL BE CONCEALED. PROVIDE DMX CONTROL AND HARDWARE. UTILIZE ROUTING WITHIN BRACKET ARM SUPPORTS AND PROVIDE PERMANENT WIRE MANAGEMENT (COLOR TO MATCH SUPPORTS) FOR ANY OTHER EXPOSED CABLING. SEE E6 SERIES FOR MORE INFORMATION.

SW DC BRIDGE/UNDERPASS **LIGHTING PROJECT**

4TH AND E ST. SW. WASHINGTON, D.C. 20024

SMITHGROUP

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1700 NEW YORK AVENUE NW SUITE 100 WASHINGTON, DC 20006 202.842.2100 smithgroup.com

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REV DATE

2022 0425

2021 0806

CFA REVISION DDOT REVISIONS 100% CONSTRUCTION DOCUMENTS

SEALS AND SIGNATURES


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SHEET TITLE

FIRST LEVEL **ELECTRICAL PLANS**

PROJECT NUMBER



GENERAL	SHEET	NOTES
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- A. CONTRACTOR TO VERIFY DDOT ILLUMINANCE REQUIREMENTS ARE MET IN THE FIELD AND EXCHANGE FIXTURES IF NEEDED TO ACHIEVE THE LIGHTING LEVELS DESIRED.
- TO ACHIEVE THE LIGHTING LEVELS DESIRED.

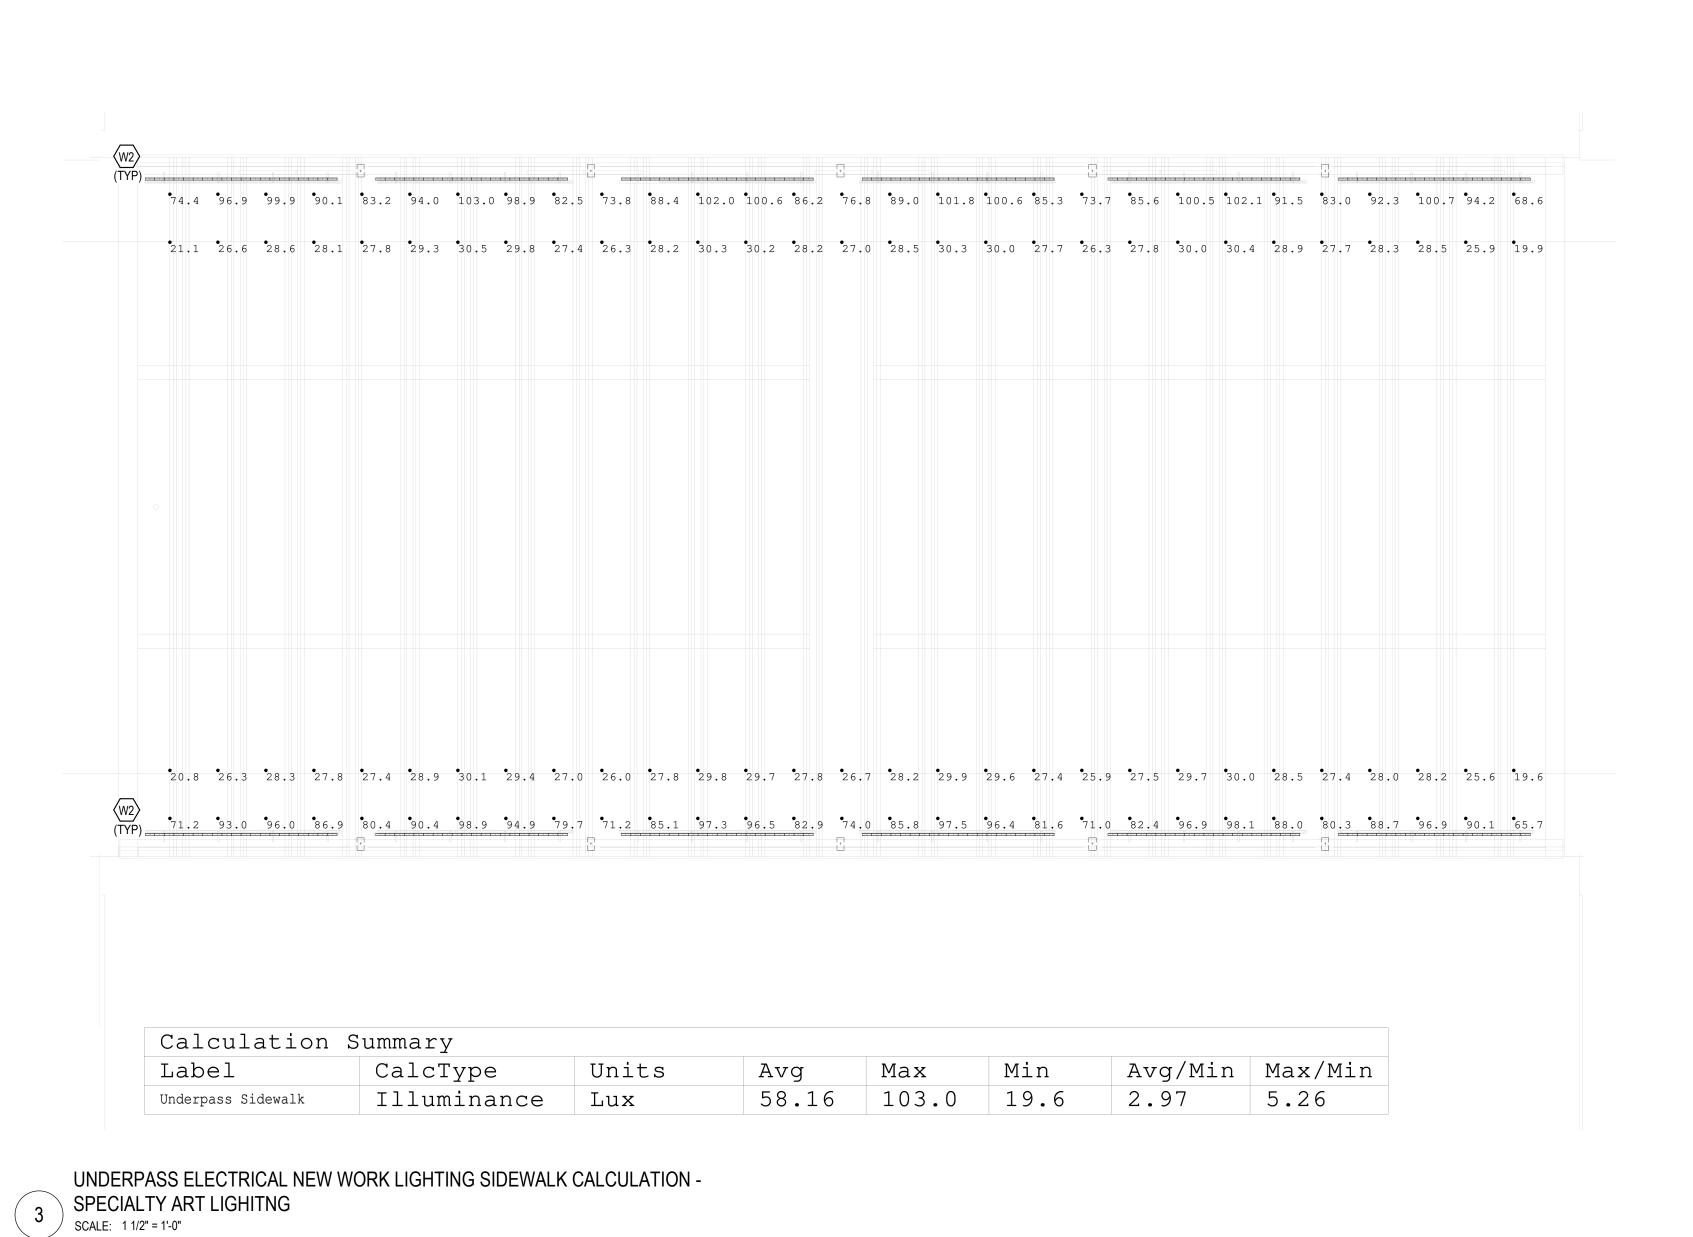 B. PROVIDE ADDITIONAL CONDUIT, JUNCTION BOXES AND ANY OTHER COMPONENTS SHOULD FIXTURES NEED TO BE LOWERED TO MEET THE REQUIRED LIGHT LEVELS.
- C. LIGHT LEVELS ARE BASED ON THE EXISTING CONDITIONS AND SUGGESTIONS FROM: CHAPTER 43 OF THE 2019 DDOT DESIGN AND ENGINEERING MANUAL, CHAPTER 4 OF THE 2013 DDOT STREETLIGHTING POLICY AND GUIDELINES, AND IES RP-8-18.

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CFA REVISION	1	2022 1104
100% CONSTRUCTION DOCUMENTS		2021 0806

○ SHEET KEYNOTES


SEALS AND SIGNATURES
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SHEET TITLE

ELECTRICAL LIGHTING CALCULATIONS

PROJECT NUMBER

E3.1

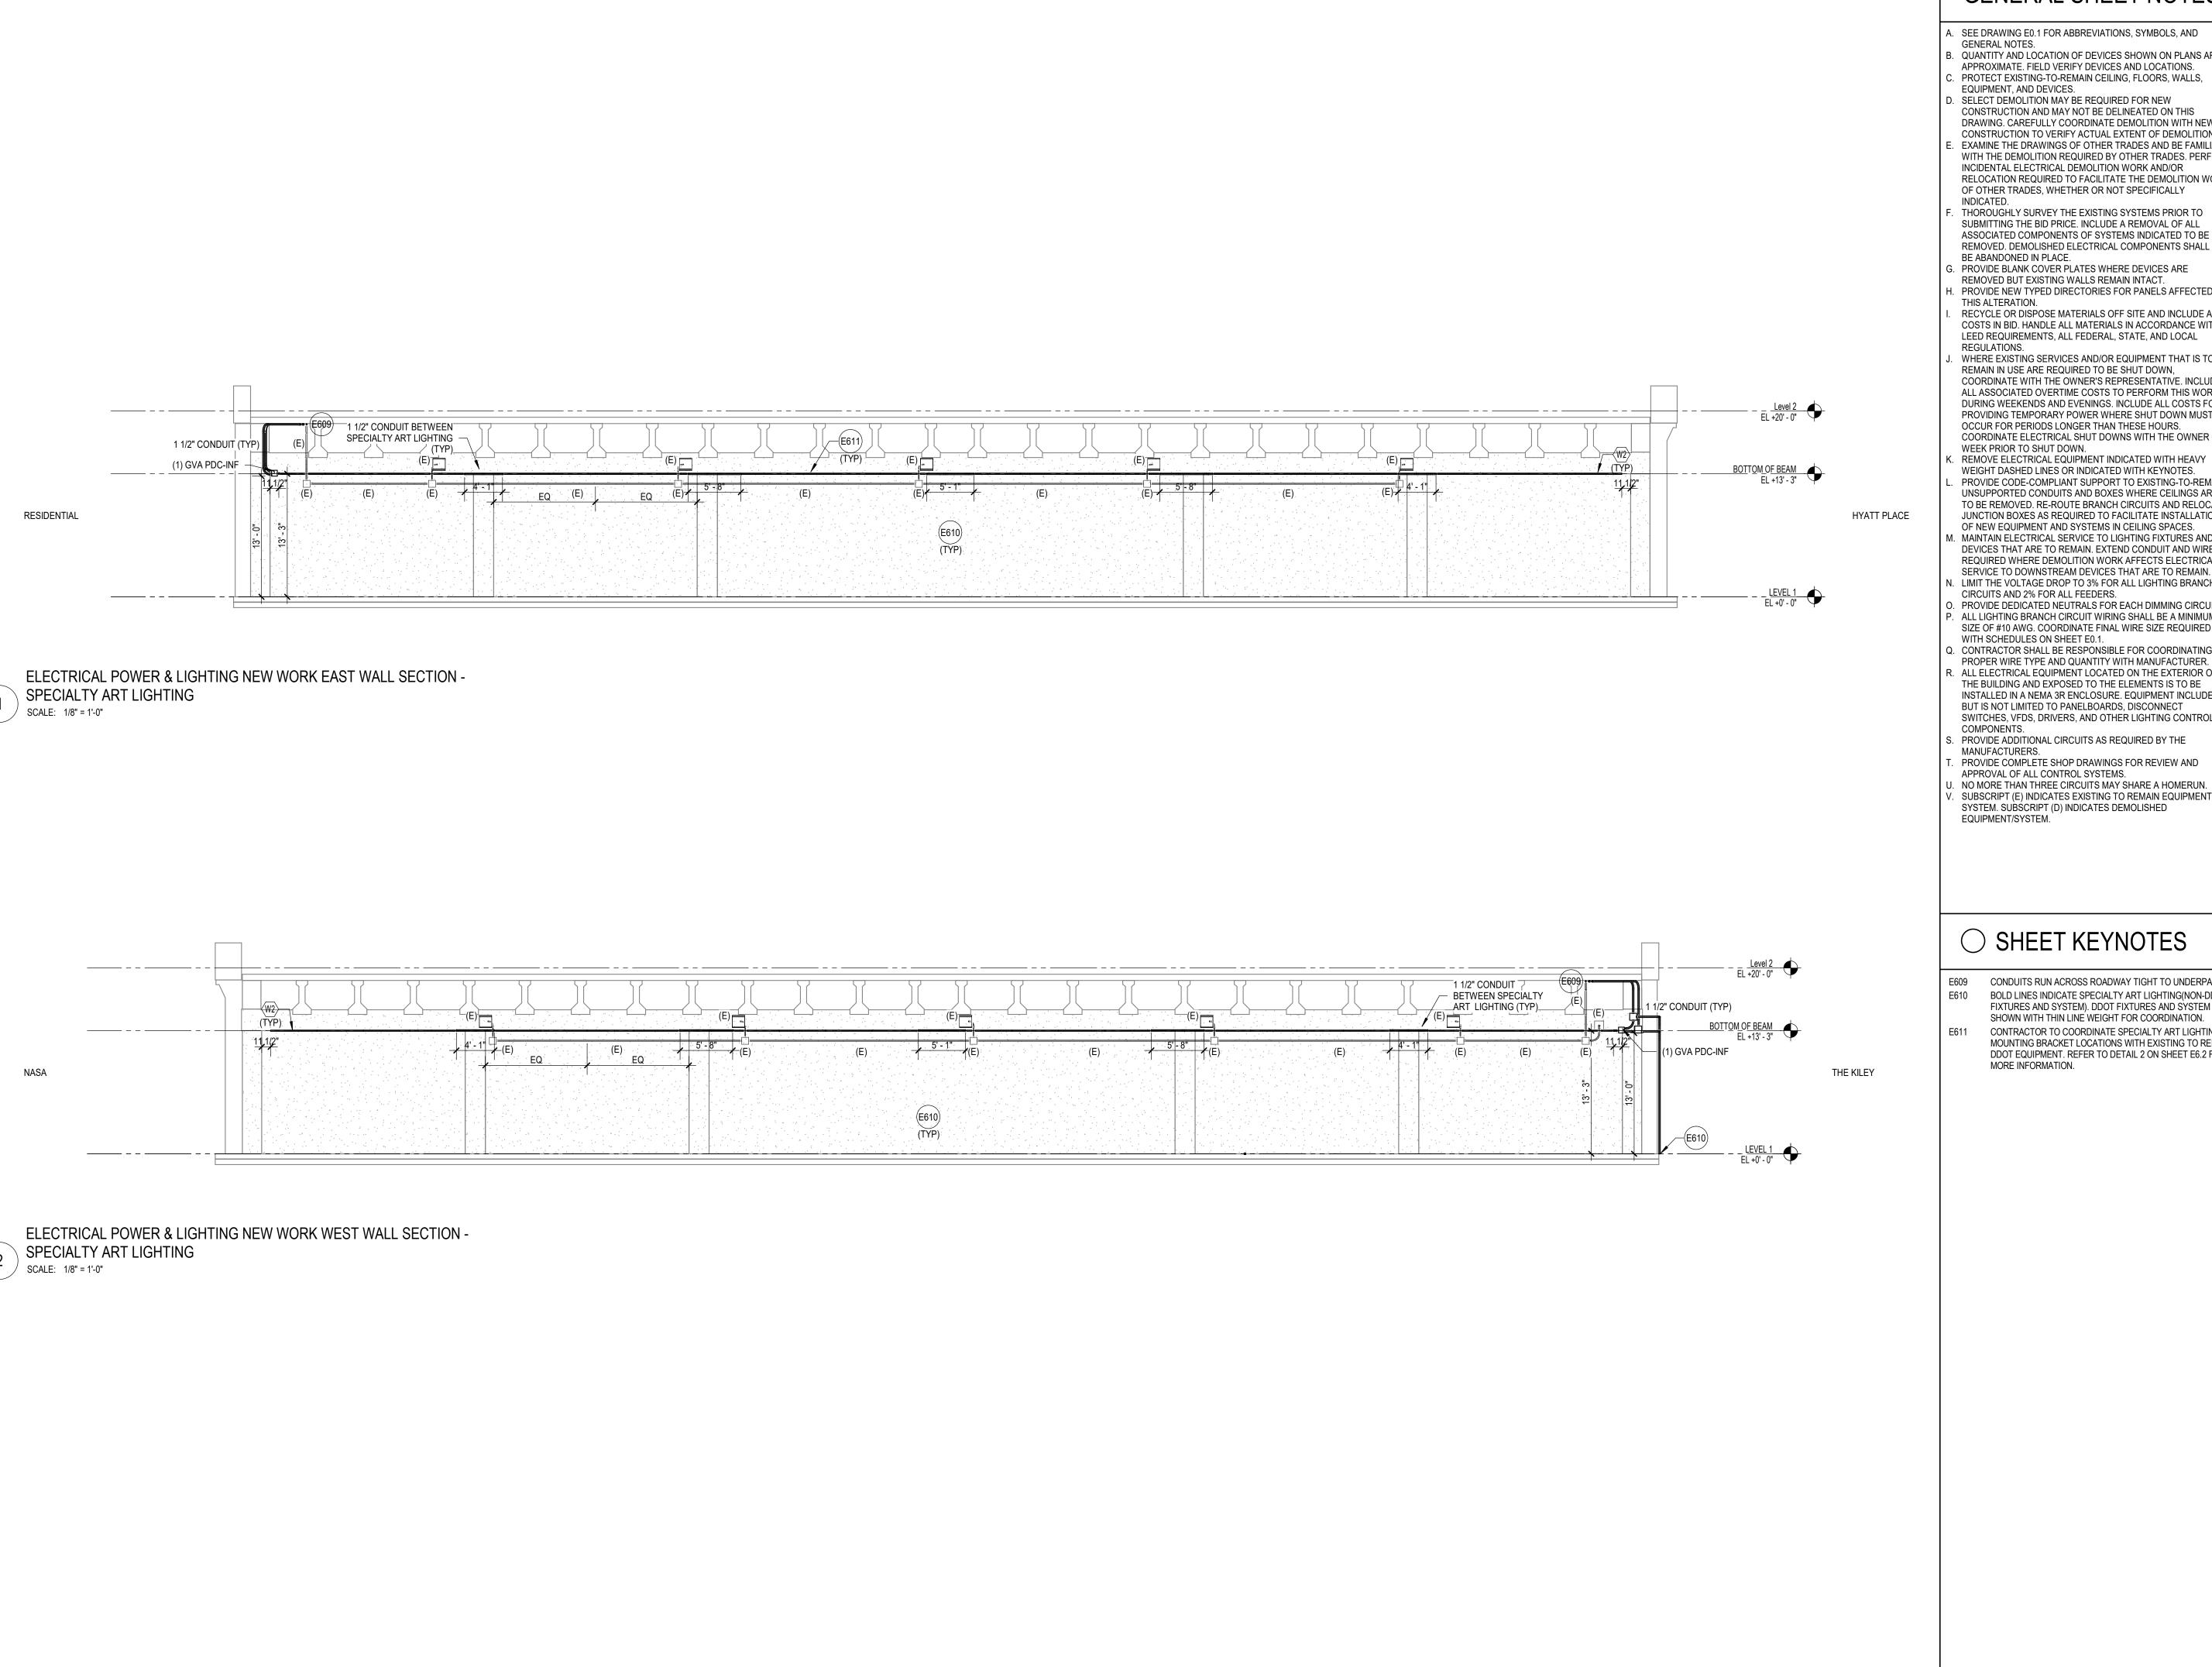

GENERAL SHEET NOTES

- SEE DRAWING E0.1 FOR ABBREVIATIONS, SYMBOLS, AND
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- WEIGHT DASHED LINES OR INDICATED WITH KEYNOTES. PROVIDE CODE-COMPLIANT SUPPORT TO EXISTING-TO-REMAIN UNSUPPORTED CONDUITS AND BOXES WHERE CEILINGS ARE TO BE REMOVED. RE-ROUTE BRANCH CIRCUITS AND RELOCATE JUNCTION BOXES AS REQUIRED TO FACILITATE INSTALLATION OF NEW EQUIPMENT AND SYSTEMS IN CEILING SPACES.
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- PROVIDE COMPLETE SHOP DRAWINGS FOR REVIEW AND APPROVAL OF ALL CONTROL SYSTEMS. NO MORE THAN THREE CIRCUITS MAY SHARE A HOMERUN.
- SUBSCRIPT (E) INDICATES EXISTING TO REMAIN EQUIPMENT / SYSTEM. SUBSCRIPT (D) INDICATES DEMOLISHED EQUIPMENT/SYSTEM.
- CFA REVISION 2022 1104 DDOT REVISIONS 2022 0425 100% CONSTRUCTION DOCUMENTS 2021 0806

SW DC

4TH AND E ST. SW.

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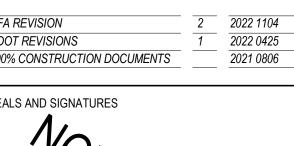
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BRIDGE/UNDERPASS

LIGHTING PROJECT

○ SHEET KEYNOTES

- CONDUITS RUN ACROSS ROADWAY TIGHT TO UNDERPASS. BOLD LINES INDICATE SPECIALTY ART LIGHTING(NON-DDOT FIXTURES AND SYSTEM). DDOT FIXTURES AND SYSTEM SHOWN WITH THIN LINE WEIGHT FOR COORDINATION.
- CONTRACTOR TO COORDINATE SPECIALTY ART LIGHTING MOUNTING BRACKET LOCATIONS WITH EXISTING TO REMAIN DDOT EQUIPMENT. REFER TO DETAIL 2 ON SHEET E6.2 FOR MORE INFORMATION.




REV DATE

SEALS AND SIGNATURES

ELECTRICAL SECTIONS

PROJECT NUMBER


E6.1

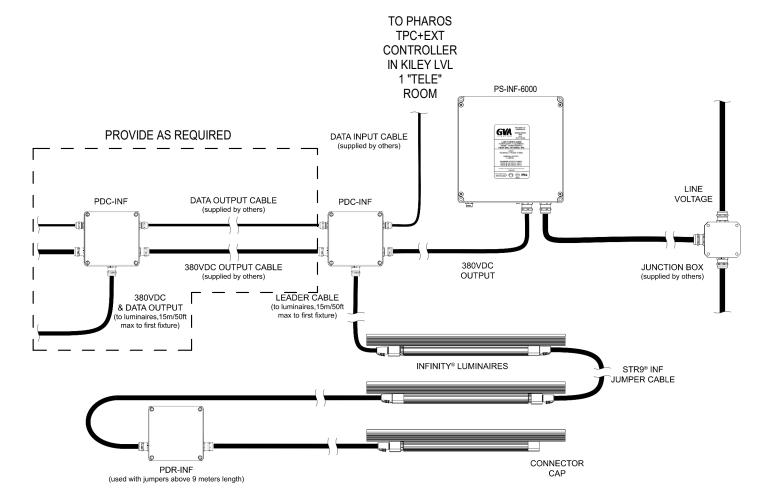


1. COORDINATE DMX PROGRAMMING WITH SWBID TO ESTABLISH SCHEDULES AND SCENES. FINAL LIGHTING SEQUENCES AND SCENES TO BE REVIEWED AND APPROVED BY OWNER. 2. CONTRACTOR TO SEND SHOP DRAWINGS FOR REVIEW REGARDING THE DMX CONTROL SYSTEM.

3. CONTRACTOR TO PROVIDE ALTERNATE PRICING WHERE THE TPC+EXT IS CONNECTED TO THE PHAROS CLOUD, ALLOWING REMOTE CONTROL OF THE CONTROLLER. THE BASIS OF DESIGN ABOVE IS LOCAL CONTROL IN THE KILEY LVL 1 "TELE" ROOM. 4. CONTRACTOR TO SUPPLY ALL COMPONENTS NOTED "SUPPLIED BY OTHERS" ABOVE. 5. TERMINAL BLOCKS INSIDE PDC-INF ACCEPT 12AWG MAX.

TYPICAL LIGHTING CONTROL DIAGRAM SCALE: NOT TO SCALE

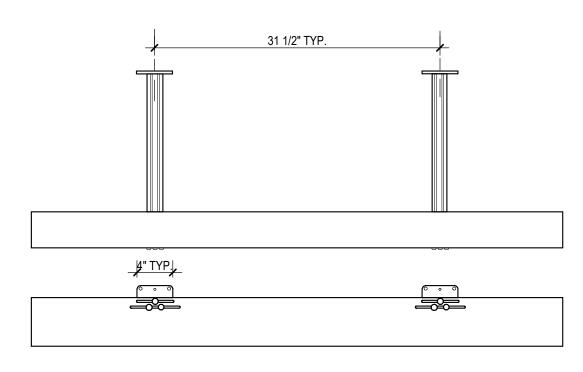

PLAN AND ELEVATION VIEW SCALE: 1"=1'-0"

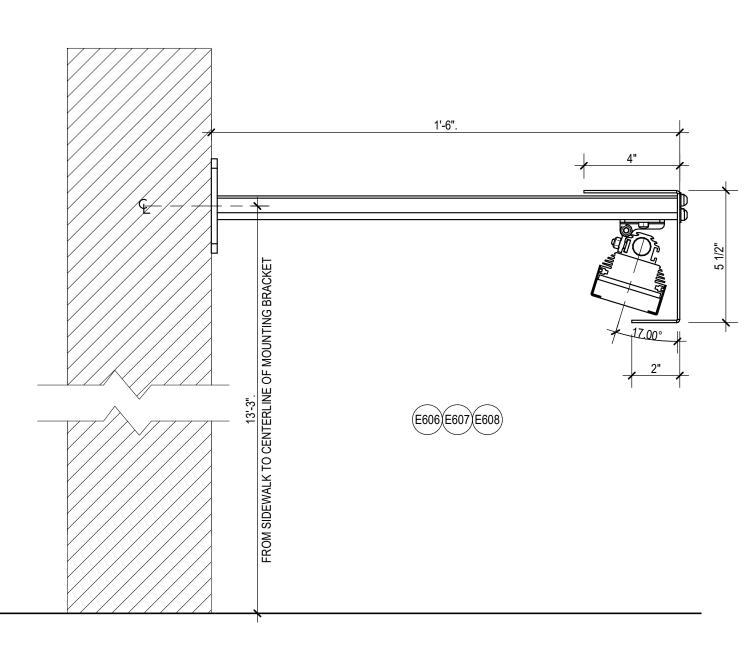

LIGHT FIXTURE MOUNTING DETAIL SCALE: 3" = 1'-0"

Panelboard: (E)H1W

Location: (E) THE KILEY - LVL 1 "TELE" ROOM Supply From: (E) THE KILEY - "HOUSE SWBD #1" Mounting: Surface

Enclosure: Type 1

Volts: 208Y/120 Phases: 3 Wires: 4

A.I.C. Rating: 65,000 Mains Type: MLO Bus Rating: 400 A


CKT	Circuit Description	Trip	Poles	,	VA)	В (VA)	C (VA)	Poles	Trip	Circuit Description	CK
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3	(2) 317 (11 (7 (2 (7)))	2071				2000	2500			3	35 A	(E) LOADING EUH-4	4
5	(E) TRASH RM EUH-2	30 A	2					2500	0				6
7	(_)			2500	2000					2	25 A	(E) LOADING EWH-1	8
9	(E) LEASING FCU-4	15 A	2			890	2000			_			10
11	` '							890	1000	1	20 A	(E) LOBBY BB HEATER	1:
13	(E) LEASING RECS	20 A	1	900	1000					1		(E) LOBBY BB HEATER	1.
15	(E) LEASING RECS	20 A	1			1080	1000			1	20 A	(E) LOBBY BB HEATER	10
17	(E) LOBBY BB HEATER	20 A	1					1000	1000	1	20 A	· ·	18
19	(E) LOBBY BB HEATER	20 A	1	1000	360					1	20 A	(E) LEASING BATH RECS	20
21	(E) LOBBY RECS	20 A	1			900	1080			1		(E) LOBBY RECS	22
23	(E) LOBBY REF	20 A	1					1200	1200	1	20 A	(E) LOBBY COFFEE MACH	24
25	(E) LVL 2 TELCOM RECS	20 A	1	360	720					1	20 A	(E) LOBBY DESK REC	20
27	(E) LVL 2 TELCOM RECS	20 A	1			360	1080			1	20 A	(E) LVL 1 RECS	28
29	(E) LOBBY DESK RECS	20 A	1					360	360	1	20 A	(E) LOBBY DESK REC	3
31	(E) LVL 1 RECS	20 A	1	1080	2000								3
33	(E) AMENITY OFFICE REC	20 A	1			720	2000			3	25 A	(E) LOADING DOCK DOOR	3
35	(E) COPY MACHINE	20 A	1					1200	2000				3
37				2800	1200					1	20 A	(E) PANTRY REF	3
39	(E) LVL 1 COMPACTOR	25 A	3			2800	1000			1	20 A	(E) PANTRY DISPOSER	4
41								2800	1200	1	20 A	(E) PANTRY DISHWASHER	4:
43	(E) PANTRY SMALL APP	20 A	7 7 7	1500	360					1	20 A	(E) LVL 1 TELECOM RECS	4
45	(E) PANTRY SMALL APP	20 A	1			1500	360			1	20 A	(E) LVL 1 TELECOM RECS	40
47	(E) LVL 1 CORRIDOR RECS	20 A	1					720	720	1	20 A	(E) LVL 2 CORRIDOR RECS	4
49	(E) PANTRY MICROWAVE	20 A	1	1200	1000								5
51						1000	1000			2	20 A	(E) LEASING EWH-2	5:
53	(E) LOADING EWH-2	20 A	2					1000	800	1	20 A	(E) LVL 2 LIGHTS	54
55	SPARE	20 A	1	0	800					1	20 A	(E) LVL 1 LIGHTS	56
57	SPARE	20 A	1			0	1200			1	20 A	(E) LOADING DOCK LTG	58
59	SPARE	20 A	1					0	800	1	20 A	(E) LEASING OFFICE LTG	60
61	(E) LEASING OFFICE LTG	20 A	1	900	1200					1	20 A	(E) LEASING OFFICE LTG	6:
63	(E) LEASING OFFICE LTG	20 A	1			600	0			1	20 A	SPARE	64
65	(E) LOADING DOCK FAN	20 A	1					400	0	1			6
67				3330	6300								6
69	(E) LOADING UH-7	35 A	3			3330	6300			3	70 A	(E) LOADING DOCK DH-1	7
71								3330	6300				7:
73	4TH ST. UNDERPASS LTG - KILEY (WEST			888	888							4TH ST. UNDERPASS LTG - HYATT (EAST	74
75	WALL)	20 A	2			888	888			2	20 A	WALL)	7
77	4TH ST. UNDERPASS LTG CONTROL	20 A	1			300	333	180	0	1	20 A	SPARE	78
79	C.	2071	<u> </u>	2990	9300			700		•	_0/(8
81	(E) DIMMING PANEL DP1	60 A	3	2000	2000	2990	9300			3	100 △	(E) PANEL H4W	8
83	(L) DIVIVINITO I AIVLL DI I	007				2330	3300	2990	9300	5	100 1	(-/ · / · · · · · · · · · · · · · · · · ·	8
55			l al Load:	5107	10.144		6 VA	4325					

Load Classification	Connected Load	Demand Factor	Estimated Demand	Panel	l Totals	
Equipment	1200 VA	100.00%	1200 VA			
Lighting	19002 VA	100.00%	19002 VA	Total Conn. Load:	143092 VA	
Receptacle	39420 VA	62.68%	24710 VA	Total Est. Demand:	113688 VA	
Mechanical Equipment	73470 VA	80.00%	58776 VA	Total Conn.:	397 A	
Appliance	10000 VA	100.00%	10000 VA	Total Est. Demand:	316 A	

1. ALL NEW WORK/SCOPE ARE SHOWN WITH BOLD TEXT. ALL OTHER LOADS ARE EXISTING TO REMAIN AND ARE BASED OFF OF BOTH EXISTING DRAWINGS AND A SITE SURVERY. 2. CONTRACTOR TO ENSURE SPARES NOTED AND UTILIZED ARE SPARE AND CARRY NO LOAD PRIOR TO ANY INSTALLATION. UTILIZE NEAREST EXISTING SPARE BREAKERS IF REQUIRED AND RE-WORK ANY EXISTING CIRCUIT GROUPINGS IN ORDER TO INSTALL NEW BREAKERS AS DISCOVERED WITH IN-FIELD CONDITIONS. PROVIDE ADDITIONAL/REVISED BREAKERS PER MANUFACTURER REQUIREMENTS AND SHOP DRAWINGS.

LIGHTING CONTROL SCHEDULE										
LUMINAIRE TYPE	CONTROL	AUTOMATIC DAYLIGHT RESPONSIVE CONTROL	MANUAL ON OUTPUT	BILEVEL/ DIMMING	SCHEDULED SHUTOFF	UNOCCUPIED OUTPUT	TIME DELAY (MINUTES)			
SPECIALTY LIGHTING	DMX	N.A.	N.A.	DMX DIMMING	BY OWNER	N.A.	N.A.			

1. COORDINATE DMX PROGRAMMING WITH SWBID TO ESTABLISH SCHEDULES AND SCENES. FINAL LIGHTING SEQUENCES AND SCENES TO BE REVIEWED AND APPROVED BY

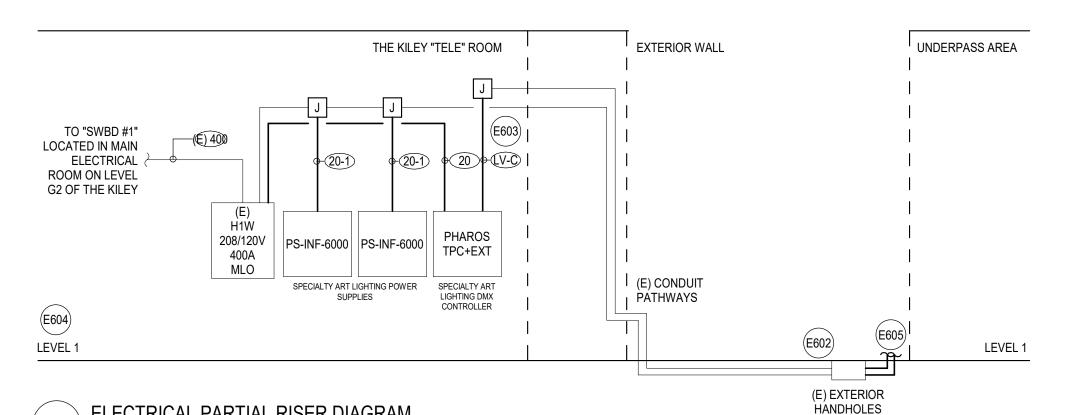

ELECTRICAL PARTIAL RISER DIAGRAM SCALE: NOT TO SCALE

GENERAL SHEET NOTES

- A. COORDINATE WITH ELECTRICAL AND LIGHTING DRAWINGS TO DETERMINE THE NUMBER OF ALL CONTROLS, MODULES, AND DEVICES. DO NOT PROVIDE QUANTITIES BASED SOLELY ON DIAGRAMS.
- PROVIDE NUMBER OF PROCESSORS REQUIRED BASED ON NUMBER OF DEVICES WITHIN SYSTEM AS REQUIRED. PROVIDE FEWEST NUMBER OF PROCESSORS AS POSSIBLE TO PROVIDE A COMPLETE CONTROL SYSTEM THAT FUNCTIONS AS DESIGNED. LOCATE PROCESSORS ON OPEN WALL IN TELECOM ROOM AS

CLOSE TO CONTROL PANELS AS POSSIBLE.

- PROVIDE CONTROL OF ALL SPECIALTY LIGHTING WITH ALL REQUIRED ACCESSORIES AND SOFTWARE FOR REMOTE CONTROLLABILITY/MANAGEMENT AND MONITORING OF ALL LIGHTING. ALL CONTROL PANELS WITHIN PROJECT TO TIE INTO CENTRAL SYSTEM SOFTWARE. SOFTWARE TO BE INSTALLED ON DEVELOPER'S COMPUTERS. QUANTITY AND LOCATION OF SOFTWARE INSTALL AS REQUIRED OR DIRECTED BY DEVELOPER. FINAL LOCATION OF LIGHTING CONTROLS SYSTEM TO BE
- DETERMINED BY DEVELOPER. PROVIDE ADDITIONAL CIRCUITS AS REQUIRED PER
- MANUFACTURER. PROVIDE COMPLETE SHOP DRAWINGS FOR REVIEW AND
- APPROVAL OF ALL CONTROL SYSTEMS. FINAL LIGHTING SEQUENCES AND SCENES TO BE REVIEWED AND APPROVED BY OWNER.

WASHINGTON, D.C. 20024

4TH AND E ST. SW.

SW DC

SMITHGROUP

BRIDGE/UNDERPASS

LIGHTING PROJECT

500 GRISWOLD **SUITE 1700** DETROIT, MI 48226 313.983.3600 smithgroup.com

1700 NEW YORK AVENUE NW SUITE 100 WASHINGTON, DC 20006 202.842.2100 smithgroup.com

SHEET KEYNOTES

E602 (2) EXISTING HANDHOLES LOCATED ADJACENT TO UNDERPASS WITHIN KILEY'S PROPERTY BOUNDARY. CONTRACTOR TO UTILIZE EXISTING CONDUITS FROM BUILDING TO HANDHOLES. PROVIDE NEW CONDUITS FROM HANDHOLES TO NEW SPECIALTY ART LIGHTING AS INDICATED ON DRAWINGS. POWER WIRING TO BE SEPARATE FROM DATA / CONTROL WIRING AT ALL TIMES. E603 DATA INPUT CABLES TO BE JOINED INTO THE (1) EXISTING 1.5" CONDUITS. CONTRACTOR TO PROVIDE DATA CABLING FROM CONTROLLER TO PDC-INF LOCATIONS, CONTRACTOR TO

COORDINATE FINAL TERMINATION SIZING, WIRING TYPES AND RECOMMENDATIONS. NEW LIGHTING CONTROL DEVICES AND POWER SUPPLIES TO BE MOUNTED ON OPPOSITE WALL FROM (E)H1W. PROVIDE 4'-0" CLEARANCE IN FRONT OF NEW COMPONENTS. APPROXIMATE DISTANCE IS 30'-0".

E604 EXISTING PANELBOARD AND FEEDER SHOWN FOR REFERENCE ONLY. NEW SCOPE DOES NOT ALTER ELECTRICAL DISTRIBUTION EQUIPMENT AND ONLY AFFECTS CIRCUITS AS INDICATED WITHIN PANELBOARD SCHEDULE. E605 NEW CONDUIT TO EXTEND FROM EXISTING HANDHOLE TO

SPECIALTY ART LIGHTING IN UNDERPASS. SEE E2.1 AND E6.1 FOR CONTINUATION AND MORE INFORMATION. E606 FINAL AIMING TO BE PERFORMED AND REVIEWED WITH LIGHTING

DESIGNER ON SITE. E607 FINAL DIMENSIONS OF GLARE SHIELD TO BE DETERMINED VIA LIGHT FIXTURE SAMPLE REVIEW AND MOCKUP. PROVIDE SHOP DRAWINGS OF CUSTOM CONTINUOUS GLARE SHIELD ATTACHED TO MOUNTING ARMS FOR REVIEW AND APPROVAL. GLARE SHIELD TO BE MINIMUM 11-GAUGE (1/8") BRAKE-FORMED ALUMINUM, GREY POWDER COATED TO MATCH FIXTURE, WITH COUNTERSUNK FASTENERS AND BUTT SEAMS BETWEEN SECTIONS, BACKED WITH SPLICE SHEET AT SEAM LOCATION.

E608 CONTRACTOR TO CONFIRM MOUNTING HEIGHT WITH ARCHITECT PRIOR TO INSTALLATION AFTER IN-FIELD VERIFICATION OF ABOVE FINISHED GROUND TO CENTER OF BRACKET DIMENSION.

REV	DATE
	-
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1	2022 1104
	2021 0806

SEALS AND SIGNATURES



FEEDER SCHEDULE

(E) 400 4#500KCMIL + 1#3 G, 4" C 20 2#12 + 1#12 G, 3/4" C 20-1 3#10 + 1#10 G, (1) 1 1/2" C

LV-C (1) 1 1/2" C

ELECTRICAL DETAILS

PROJECT NUMBER