

## APPLICATION AND REFERRAL TO THE US COMMISSION OF FINE ARTS FOR OLD GEORGETOWN REVIEW

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HPA			l

In accordance with the Old Georgetown Act of 1950 (Public Law 808, 81st Congress) this application/transmittal is being transmitted to the US Commission of Fine Arts (CFA) for review and recommendation before a building permit can be issued. Work in Georgetown is also subject to a coordinated historic preservation review under the DC Historic Landmark and Historic District Protection Act of 1978. These reviews are initiated with the completion and submission of this form. THIS IS A REQUEST FOR THE FOLLOWING REVIEW BY THE COMMISSION OF FINE ARTS: CONCEPTUAL REVIEW to receive guidance at the early stages of design PERMIT REVIEW to receive a recommendation on building permit application No. \_\_\_ I have submitted a permit application with the DC Department of Consumer and Regulatory Affairs 1. OWNER, APPLICANT, AND PROPERTY INFORMATION Project Address: 1436 36th St NW, Washington, D.C. 20007 Square: 1248 Lot: 0129 (To find your square and lot, see www.propertyquest.dc.gov) Property Owner's Name: Georgetown University Owner Address (if different from project address): 3700 "O" St. NW, Washington, D.C. 20007 Owner Phone: 202-934-6270 Owner Email: nh627@georgetown.edu Applicant's Name (if different from owner): Anthony Gammon, PE, AVP of Capital Projects Agent's Capacity: 

| Tenant | Architect | Contractor | Contract Purchaser | Expediter | Other Agent Address (if different from owner): \_\_\_\_\_ Agent Phone: \_\_\_\_\_ Agent Email: \_\_\_\_\_ I am currently the owner of the property I am a homeowner currently receiving the DC homestead deduction for this property I am an authorized representative of the property owner ď I am or represent a potential purchaser of the property 2. SUBMISSION MATERIALS FOR THE COMMISSION OF FINE ARTS AND HISTORIC PRESERVATION REVIEW All materials must be submitted electronically via email to historic.preservation@dc.gov. The following digital materials are included with this application: Scaled drawings, including, as applicable, floor plans, elevations, details, and a site plan sufficient to illustrate the footprint, location, height, massing, design, and materials of the proposed work and its surrounding context; site plans should show the existing footprint of the property and adjacent buildings. Comprehensive exterior photographs of the property, showing area of proposed work, views from the street and the public alley (if applicable) and context photos (e.g., adjacent buildings, immediate surroundings, and the areas of proposed work) For more information on submission requirements, see <a href="www.cfa.gov/project-review/old-georgetown">www.cfa.gov/project-review/old-georgetown</a> or contact CFA

3. PROJECT DESCRIPTION (CHECK ALL THAT APPLY)


staff at 202-504-2200

Replacement of existing siding; repair of existing railing; installation of new rear elevation window

	YES	No	UNSURE	(over
Is the proposed work visible from a public street or alley?	vZ			
Will there be work on the front of the building or in the front yard?				
Does the project include work in public space?		Ø		
Does the project include removal of roof or floor framing or bearing walls?		D		
Is this a Fair Housing Act request for "reasonable accommodation"?		Ø		
4. ADDITIONAL INFORMATION FOR LARGER PROJECTS				
For renovation or new construction projects exceeding 20,000 square feet, attach indicating the general nature of the project, program of uses, estimated gross floor residential units, scope of preservation work, and any other pertinent features or of sustainability. Homeowners proposing work on their own house do not need to	or area by benefits,	use, no includio	umber of ng aspect	s
5. EASEMENTS	YES	No	UNSURE	
Is there a conservation easement on the property?		<b>a</b>		
If yes, have you discussed the project with the easement holder?		₽′		
6. COMMUNITY CONSULTATION	YES	No	Unsure	
Have you shared project information with abutting neighbors?	₽′			
Have you contacted the affected Advisory Neighborhood Commission (ANC 2E)?	♥′			
Have you contacted any neighborhood community organizations? For more information about project review by ANC 2E, see www.anc2E.com or call the ANC	<b>₽</b> C at 202-33	□ 88-7427		
7. ZONING REGULATIONS AND CONSTRUCTION CODE	YES	No	Unsure	
Will the project cause a change in building footprint or lot occupancy?		₽′		
Are any zoning variances or special exceptions required for the project?		₽′		
If yes, have you discussed the project with the Zoning Administrator?		♥′		
If yes, have you discussed the project with the Office of Planning?		♥′		
Is any building code relief required for the project?		₽⁄		
Briefly describe the nature of any zoning variances or code relief being sought: N/A				
	2/4/2023	3		
When completed, submit this form with all plans, photographs, and other attachments to (HPO) via email to <a href="mailto:historic.preservation@dc.gov">historic.preservation@dc.gov</a> . Upon review of this submission, CFA or HPO agent for consultation, and may request additional information if determined necessary to re-	staff may view the p	contact roject.	t the owne	er or
Referral to CFA or the Historic Preservation Review Board, if required, may be deferred if in sufficient time to allow staff evaluation and preparation for review. All application materia and are made available to the public for inspection. For more information, see www.cfa.gov	als are par	t of the	public re	cord
Historic Preservation Office				



Historic Preservation Office DC Office of Planning (202) 442-8800 historic.preservation@dc.gov

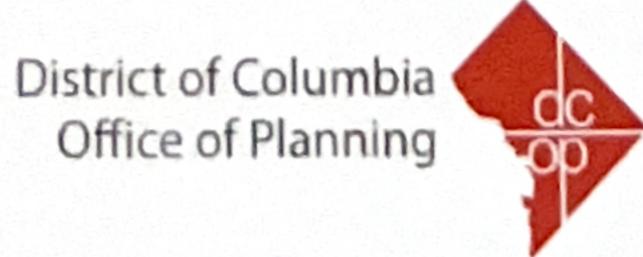

ABBREVIATIONS and Angle FIRE DEPARTMENT VALVE PERFORATED PIPE GUARD FIRE EXTINGUISHER PLATE/PROPERTY LINE CENTERLINE FIRE EXTINGUISHER CABINET PLAM PLAS PLYWD PNL POL PR PLASTIC LAMINATE FINISH FACE CHANNFI REFLECTED CEILING PLAN LEGEND MATERIALS LEGEND FINISH FLOOR ELEVATION PLASTER DIAMETER PLYW00D NUMBER, POUND(S) FIRE HOSE CABINET FIRE HOSE VALVE CABINET -1436 36TH ST NW POLISHED PAIR FLAT HEAD MACHINE SCREW AIR CONDITIONING FLAT HEAD SCREW ACOUSTICAL BAFFLE PRCST
PROJ
PSF
PSI
PT
PTD
PTN
PVC
PVG
PWD ARCHITECTURAL CONCRETE MASONRY **PRECAST** FLAT HEAD WOOD SCREW **PROJECT** ISOLATED CEILING ABOVE EARTH ACOUSTIC(AL) POUNDS PER SQUARE FOOT SEE DETAIL 28/A920 ACP ACT FLASHING ACOUSTICAL CEILING PANEL POUNDS PER SQUARE INCH FLEXIBLE GRAVEL ACOUSTICAL CEILING TILE SPRINKLER FLOORING Yates Field House PAINTED ADJUSTABLE/ADJACENT CONCRETE CEILING SUPPLY FLUOR FO FOS FRPF FS PARTITION FLUORESCENT ACCESS DOOR POLYVINYL CHLORIDE WALL SUPPLY ABOVE FINISH FLOOR FACE OF CMU/ACM/GCMU PAVING ANC FACE OF STUD/SLAB/STRUCTURE ANCHOR return FIREPROOF(ING) PLYW00D AIR HANDLING UNIT COMMON/FACE BRICK FULL SIZE/FLOOR SINK LINEAR DIFFUSER QUARRY TILE FOOT OR FEET CUT STONE QUANTITY WALL WASH DOWNLIGHT ANNUNCIATOR CAST STONE RISER/REGISTER RECESSED CAN ACCESS PANEL FIRE VALVE CABINET ARCHITECTURAL PRECAST CONCRETE return air RAD/R RBR RCP RADUIS PENDANT LIGHT FIXTURE APPROXIMATE(LY RUBBER ARCH ARCHITECT(URAL RELECTED CEILING PLAN STEEL (LARGE SCALE) GALVANIZED UNDER COUNTER LIGHT FIXTURE ABUSE REŠISTANT GYPSUM WALL BOARD RD RECPT REF ROOF DRAIN GRAB BAR RECEPTACLE WALL MOUNT FIXTURE ALUMINUM (LARGE SCALE) ACOUSTIC WALL PANEL GENERAL CONTRACTOR REFERENCE GLAZED CMU REFRIG REFRIGERATOR BOTTOM OF CURB BRASS/BRONZE (LARGE SCALE) INDIRECT WALL MOUNTED LIGHT FIXTURE REG REINF REQD RESIL RET RETG REGISTER REINFORCE(MENT)(ING) BITUMINOUS GLASS/GLAZING SURFACE MOUNTED FIXTURE BLDG BLK REQUIRED BUILDING RESILIENT BLOCK CONTINUOUS WOOD FRAMING OR BLOCKING EXHAUST FAN GYPSUM WALL BOARD BLKBD BLACK BOARD return BLKG BLKHD RETAINING CELING FAN/LIGHT DISCONTINUOUS WOOD BLOCKING OR SHIMS REVISION, REVERSE BULKHEAD RESILIENT FLOORING DUPLEX OUTLET BOT **ROOFING BOTTOM** HOSE BIB ROBE HOOK/RIGHT HAND BRG PL BEARNING PLATE HOLLOW CORE QUADPLEX OUTLET SEMI-RIGID/BATT/LOOSE INSULATION/SAFING HANDICAP(PED) rain leader SWITCHED LEG OUTLET BRICK HARDWOOD ROUGH OPENING/ROUND RIGID INSULATION BRACKE HARDWARE SINGLE POLE SWITCH resilient ventilated BASEMENT HOUSEKEEPING RAIN WATER CONDUCTOR 3-WAY SWITCH GLASS (LARGE SCALE) BFTWFFN HOLLOW METAL BUILT UP ROOFING HOLLOW METAL FRAME MOTION SENSOR SWITCH HORIZONTAL(LY) CERAMIC/QUARRY TILE MOTION SENSOR YARD LIGHT COURSE(S) / CARPET Supplý air SOUND ATTENUATION BLANKETS CAB CBB CEM CER ← PSTNW SEE ARCHITECTURAL DRAWINGS HTG HVAC HW CEMENTITIOUS BACKER BOARD SPEAKER SEALED CONCRETE / SOLID CORE HEATING/VENTILATION/AIR CONDITIONING CEMENT ACOUSTICAL TILE OR CEILING PANEL SCHEDULE SOLID CORE WOOD DOOR SCH SCWD SD SECT SF SFT SHR SHT SHT SHVLG SIM SLNT SM SMS SPD SPEC SPKR SO CERAMIC CARBON MONOXIDE DETECTOR -1436 36TH ST NW SEALANT & BACKER ROD ICCMU INTEGRALLY COLORED CMU SMOKE DETECTOR CHANGE IN FLOORING INSIDE DIAMETER CAST IN PLACE SMOKE DECTECTOR SECTION Learning Center SAND/MORTAR/GROUT/GYPSUM BOARD/ STUCCO SQUARE FOOT (FEET) CONTROL JOINT INCAND INSUL INCANDESCENT CL CLG CLKG CLL CLO CLR CENTER LINE STRUCTURAL FACING TILE TELEPHONE INSULATION SHOWER CEILING CAULKING Georgetown University INTRM INV INTERMEDIATE VOICE / DATA CONTRACT LIMIT LINE SHEATHING invert SHELVING SIMILAR ZONING ANALYSIS - ZONE R-20 **JANITOR** CM CONSTRUCTION MANAGER SEALANT USE: EXISTING - RESIDENTIAL JOIST CMU CNTR CO CONCRETE MASONRY UNIT SHEETMETAL JOINT PROPOSED - RESIDENTIAL SEE MECHANICAL DRAWINGS COUNTER CLEAN OUT SHEET METAL SCREW KNOCKED DOWN COL COLUMN SEE PLUMBING DRAWINGS KITCHEN COMB COMP CONC CONSTR CONT COMBINATION SPECIFICATION(S) KNOCK OUT COMPACT(ED) KICK PLATE 720 SF CONCRETÈ SQUARE 1204.1 LOT COVERAGE 395.9 SF 395.9 SF (55%) 432 (60%)MAX CONSTRUCTION STAINLESS STEEL LONG/LENGTH SSD STC STD CONTINUOUS SEE STRUCTURAL DRAWINGS LABORATORY SETBACKS - FRONT ALIGN W/ ADJ ALIGN W/ ADJ COP CORR CPT CRFS COPPER SOUND TRANSMISSION CLASS(IFICATION) LAMINATE(D) CORRIDOR STANDARD SIDE CARPET COLD ROLLED FORMED STEEL STEEL STORAGE STRUCTURAL STL STOR STRUC SUSP SYM SYS SWG LB(S)
LC
LCKR
LEV
LF
LG
LH
LIN
LP
LPT
LT 0 IMPERVIOUS SURFACES NO CHANGE PROPOSED LEAD COÁTED Georgetown Institute for CAST STONE LINTEL SUSPEND(ED)/SUSPENSION LEVEL COUNTERSUN LINEAR FOOT (FEET), LIGHT FIXTURE SYMMETRICAL CERAMIC TILE SYSTEM PREPARED UNDER DC BUILDING CODE 2017 CENTER SWINGING LEFT HANDED CUSPIDOR LINOLEUM TREAD COLD WATER CURTAIN WALL SYSTEM TOWEL BAR LOW POINT TACKBOARD LIGHT TEL TEMP TER SYMBOLS LEGEND DEEP/DEPTH/DRAIN TELEPHONE LIGHT WEIGHT TEMPERED LOUVER **DOUBLE** TERRAZZO DBL DEPT DET MACH MAS MATL MAX MDF MECH MEMB TRANSPARENT FINISH DEPARTMENT TG/T&G THK TONGUE & GROOVE DRAWING A214 MASONRY DRINKING FOUNTAIN THICK(NESS) MATCHLINE MATERIAL EXTERIOR WINDOW/DOOR TAG (A) THRES TO TOC TOS TOW THRESHOLD DOUBLE HUNG MAXIMUM TOP OF DIAMETER MEDIUM DENSITY FIBERBOARD TOP OF CONCRETE/CURB LOUVER TAG DIAGONAL(LY MECHANICAL OSTNW TOP OF SLAB/STEÉL DIMENSION MEMBRANE MEP MET/MTL TOP OF WALL MECHANICAL ELECTRICAL PLUMBING DISP DISPENSER REVISION METAL TELEVISION DIVISION TRANSLUSCENT WALL PANEL MEZZ MFR MH DAMPROOFING MEZZANINE KEY NOTE LOCATION MAP TYPICAL DOWN MANUFACTURER SPOT ELEVATION DOOR MANHOLE DOWNSPOUT UNDERCUT MIN MIR MISC MO MOD MR MTD MTG MULL MW MINIMUM UNIT HEATER HWH DSP DRY STANDPIPE MIRROR EQUIPMENT NUMBER UNDERWRITER'S LABORATORIES INC. DISTILLED WATER MISCELLANEOUS UNFIN UNO UR UNFINISHED DISHWASHER MASONRY OPENING UNLESS NOTED OTHERWISE MODIFIED SEALANT & BACKER ROD MOISTURE RESISTANT DRAWER PROPOSED SCOPE OF WORK: MOUNTED EAST MOUNTING 1. EXISTING EXTERIOR ENVELOPE TO REMAIN PROPERTY LINE VAPOR BARRIER MULLION EMERGENCY EYE WASH VCT VERT VEST VIF VRB EXCEPT AS NOTED BELOW. VINYL COMPOSITION TILE MICROWAVE EXTERIOR INSULATION VERTICAL(LY) 2. PROVIDE EXTERIOR SIDING TO MATCH & FINISHING SYSTEM VESTIBULÉ **EXPANSION JOINT** DOOR EXISTING-PAINT VERIFY IN FIELD FI FVATION VENTED RUBBER BASE 3. PROVIDE NEW INTERIOR STRUCTURE TO ELECTRIC(AL) INTERIOR ELEVATION NUMBER DOOR-INACTIVE LEAF NOMINAL INCLUDE FIRST AND SECOND FLOOR FRAMING EMR ELEV ENG ENCL ENT ELEVATOR MACHINE ROOM NOISE REDUCTION COEFFICIENT VINYL TILE AND STAIRS. EXISTING ROOF FRAMING ELEVATOR NOT TO SCALE VINYL WALL COVERING ENGINEER PLAN NORTH EXTERIOR BEARING WALLS, EXISTING WOOD OVERALL/OUTSIDE AIR **ENCLOSURE** WEST/WIDE/WIDTH OC OD OFCI OFOI FRAME PARTY WALLS AND FOUNDATIONS TO ENTRANCE OUTSIDE DIAMETER/OVERFLOW DRAIN EDGE OF SLAB W/O WOM WC OWNER FURNISHED, CONTRACTOR INSTALLED WITHOUT POINT OF ENTRY SITE PLAN ONLY ELECTRICAL PANEL BOARD WOMEN OWNER FURNISHED, OWNER INSTALLED 4. PROVIDE NEW INTERIOR PARTITIONS, PARTITION TYPE = = = = OPP OHMS OHWS OPER OPNG OPP OSD OZ WATER CLOSET OPPOSITE HAND EQUIPMENT CASEWORK, DOORS, FINISHES AND APPLIANCES OVAL HEAD MACHINE SCREW WOOD EXPOSED STRUCTURE ITEMS FOR DEMOLITION WIREGLASS OVAL HEAD WOOD SCREW 5. PROVIDE NEW FOUNDATION, WALL AND ROOF ELECTRIC WATER COOLER WALL HYDRANT/WATER HEATER EXP EXST EXT EXPANDED/EXPANSION INSULATION WATERPROOFING EXISTING TO REMAIN WEATHERSTRIPPING 6. PROVIDE NEW ELECTRICAL SERVICE **EXTERIOR** 

COLUMN NUMBER

COLUMN GRIDLINE

7. PROVIDE NEW MECHANICAL SYSTEM AND

WATER SERVICE AND DRAIN LINES

8. PROVIDE NEW PLUMBING FIXTURES, INTERIOR

DISTRIBUTION

OPEN SITE DRAIN OUNCE

PLANTING AREA

PRECAST

PARTICLE BOARD

PORTLAND CEMENT PLASTER

EXTR

**EXTRUDED** 

FAHRENHEIT

FIRE ALARM/GAUGE

FLOOR DRAIN/FIRE DAMPER

FAN COIL ÚNIT

FOUNDATION

WSCT WT WWF

WAINSCOT

WELDED WIRE FABRIC

DETAIL KEY




Renovations to 1436 36th St Washington DC.

Drawing Title

TITLE SHEET ABBREVIATIONS PLAT

Project No.	
	VA2005-01
Date	
	12 OCT 22

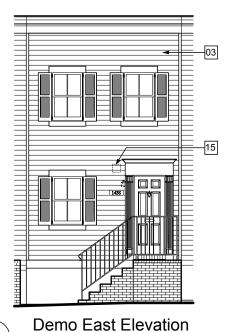

—<mark>04</mark> Тур. Relocate to above 24 house number **East Elevation** 

1/8" = 1'-0"

East Elevation



## **General Notes**

- 1. Reference schedules for additional information regarding window and door replacement and proposed exterior light fixtures
- 2. GC to coordinate testing and abatement of hazardous
- 3. Demolish existing siding. Provide new siding to match demolished siding. Paint six sides.

03A. Inspect existing decorative wood trim for water damage and deterioration. At damaged areas, clean, patch, repair, prep and repaint to match existing color.

- 4. Inspect existing wood door and window trim, casings, jambs and sills for water damage and deterioration. Patch, sand and paint repaint to match existing color.
- 5. Inspect existing stucco finish for water damage or deterioration. Clean, patch, repair, prep and repaint to match existing color.
- Refurbish exterior door and transom (where applicable), u.n.o. Remove cracked and peeling paint, prep and repaint.
- Provide new weatherstripping.
  7. Refurbish exterior windows where possible. Remove cracked and peeling paint, prep and repaint.

  8. Refurbish entrance door mail slot.

- Returbish entrains sol.
   Repair, refurbish, prep and repaint railings where applicable.
   Power wash exterior paving, site walls and exterior brick and siding, typical.


  11. Snake exterior drains, typical.
- 12. Not used
- 13. Remove unused surface run wiring at exterior. Reroute remaining required surface wiring to interior. If not feasible, run in [painted exterior conduit in straight, direct path. Paint to match adjacent material finish.
- 14. Replace house numbers in kind. Match material, style and color of existing.
- 15. Demo vent and duct
- 16. Not used
- 18.
  - Not used Refurbish gate and patch to match existing.
- Not used
- 21. Provide allowance to repair fence at back yard.
- 22. Repoint brick as needed throughout.
- 23. Not used
- 24. Refurbish exterior light fixture,
- 25. Refurbish existing wood door sill. Prep and repaint color to match existing.
- 26. Paint exist. utility box and piping to match adjacent material.
- 27. Not used
- 28. Existing condensing unit to be removed.
- 29. Install cast iron boot at downspout terminations and tie into existing storm system where possible.
- 30. Not used

- 31. Rehab shutters and hardware and prep and repaint.
  32. Not used
  33. Not used
  34. Replace west elevation siding to match east elevation
  35. Not used Replace west elevation siding to match east elevation.
- Paint wood column enclosure around existing wood column.
   Not used
- 38. Repair / refurbish stone and concrete steps / wall.
- 39. Not used
- 40. Not used
  41. Prep and repaint brick with exterior masonry paint. Clean surface and remove loose / peeling paint prior to preparation. GC to propose appropriate product prior to commencement of work.
  42. Remove damaged exterior parging and patch / repair to be smooth consistent finish and paint to match existing.
- Replace existing vinyl siding with wood siding to match east



1436 36th S

EAST ELEVATION

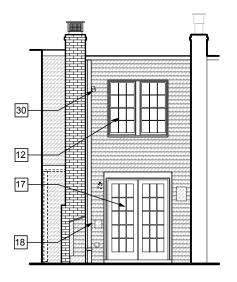

**Demo West Elevation** 

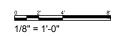






PHOTO SHOWING **EXISTING OPENING** FRAMING AT TOP OF STAIR



- 1. Reference schedules for additional information regarding window and door replacement and proposed exterior light fixtures
- 2. GC to coordinate testing and abatement of hazardous
- 3. Demolish existing siding. Inspect underlying german profile siding. Demo rotted/damage siding. Provide new German Profile siding to match existing. Paint six sides.
- 03A. Inspect existing decorative wood trim for water damage and deterioration. At damaged areas, replace with matching profile and material. At remaining areas, clean, patch, repair, prep and repaint to match existing color.
- 4. Inspect existing wood door and window trim, casings, jambs and sills for water damage and deterioration. Patch, sand and paint repaint to match existing color.
- Not used
- Provide new half lite, wood exterior doors.
- Refurbish exterior windows where possible. Remove cracked and peeling paint, prep and repaint.
- Refurbish entrance door mail slot.
- Repair, refurbish, prep and repaint railings where applicable.
- 10. Power wash exterior paving, site walls and exterior brick and siding, typical.
- 11. Snake exterior drains, typical.
- Existing window to remain
   Remove unused surface run wiring at exterior. Reroute remaining required surface wiring to interior. If not feasible, run in [painted exterior conduit in straight, direct path. Paint to match adjacent material finish.
- 14. Replace house numbers in kind. Match material, style and color of existing.
- 15. Inspect exterior vents. Remove unused and infill wall to match existing adjacent exterior finish. At operable vents, clean vent duct and vents.
- 16. Replace hose-bibs and provide with vacuum break and freeze protection.
- 17. Demo french doors18. Reinstall existing qui Reinstall existing gutter and downspoud
- Refurbish gate and patch to match existing.
- Painted metal vent cover
- 21. Provide allowance to repair fence at back yard.
- Repoint brick as needed throughout.
- Outdoor compressor elec disconnect swich Provide new exterior light fixture,
- Refurbish existing wood door sill. Prep and repaint color to match existing.
- Paint exist. utility box and piping to match adjacent material.
  - Provide new exterior light fixture
- 28. 29. Existing condensing unit to be removed.
- 30. Remove siding and replace with new wood siding-see 5/A041
- Rehab shutters and hardware and prep and repaint.
- Painted metal exterior vent cover(-behind chimney)
- Existing shadowbox fence to remain
- 34. 35. 36. 37. 38. Replace west elevation siding to match east elevation.
- Elec outlet cover
- Not used.
- Not used
- Repair / refurbish stone and concrete steps / wall.
- 39. Not used 40. Not used
- 41. Prep and repaint brick with exterior masonry paint. Clean surface and remove loose / peeling paint prior to preparation. GC to propose appropriate product prior to commencement of work. 42. Remove damaged exterior parging and patch / repair to be
- smooth consistent finish and paint to match existing. Replace existing vinyl siding with wood siding to match east
- elevation.
  43. Provide wood entry door with (2) half lite panels and single glazing. Paint 44. Provide new wood/wood, single glazed double hung,
- tempered glass window in existing opening




1436 36th S

WEST ELEVATION


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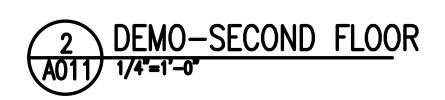



East Elevation



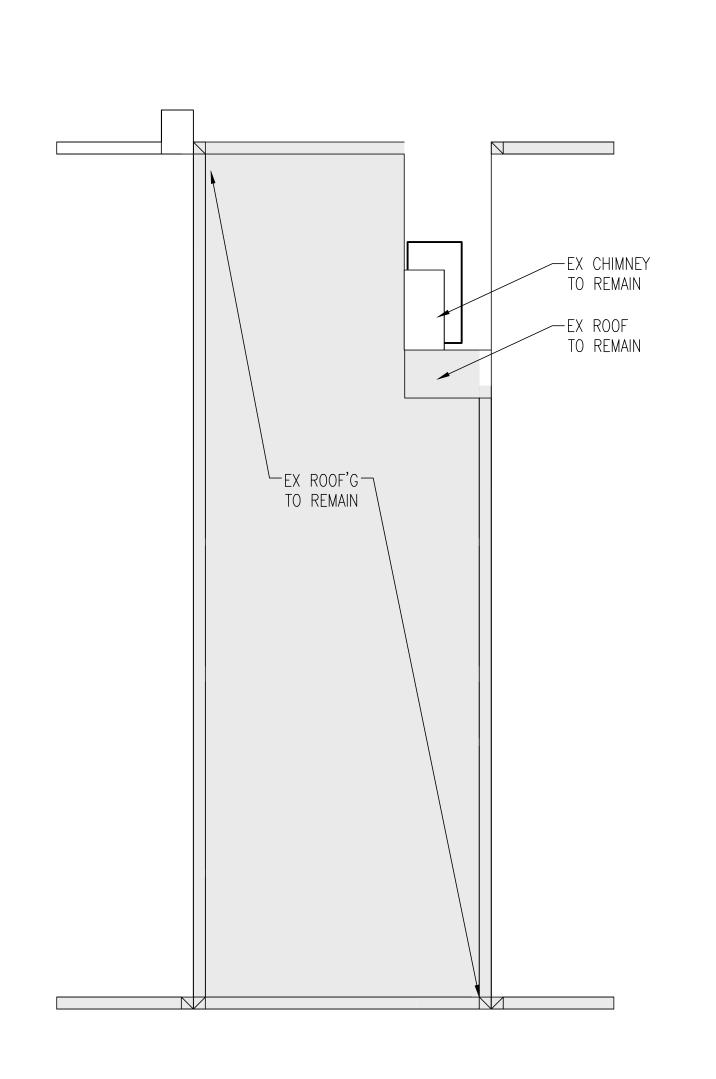



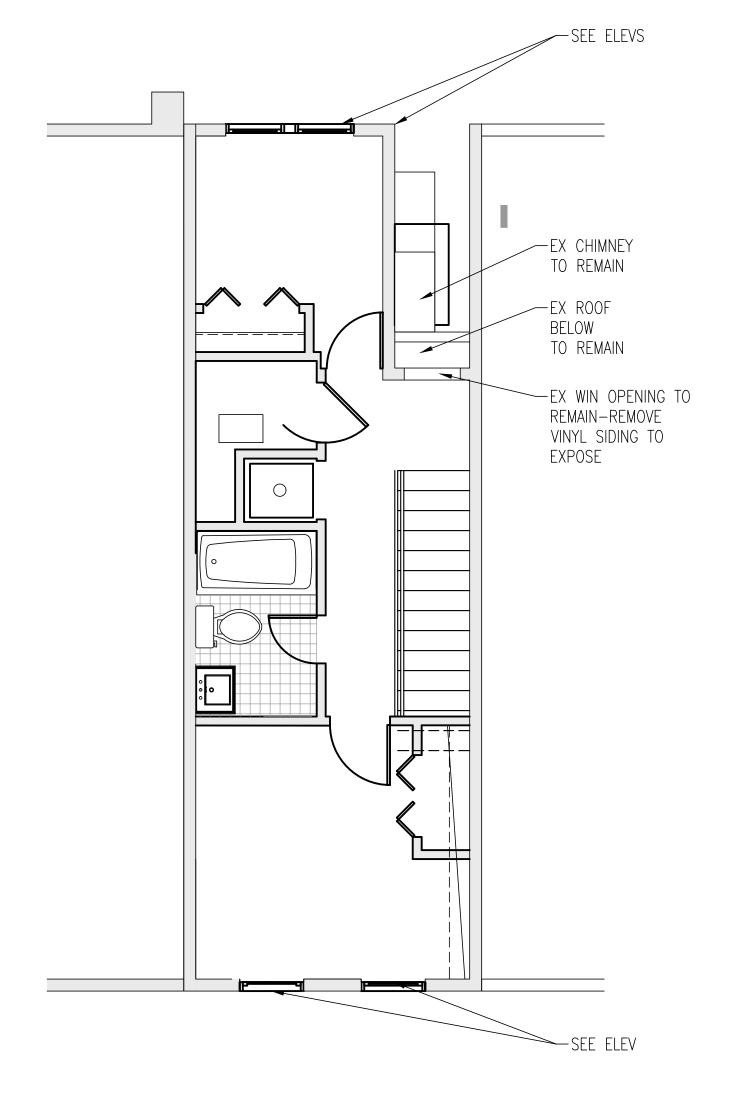

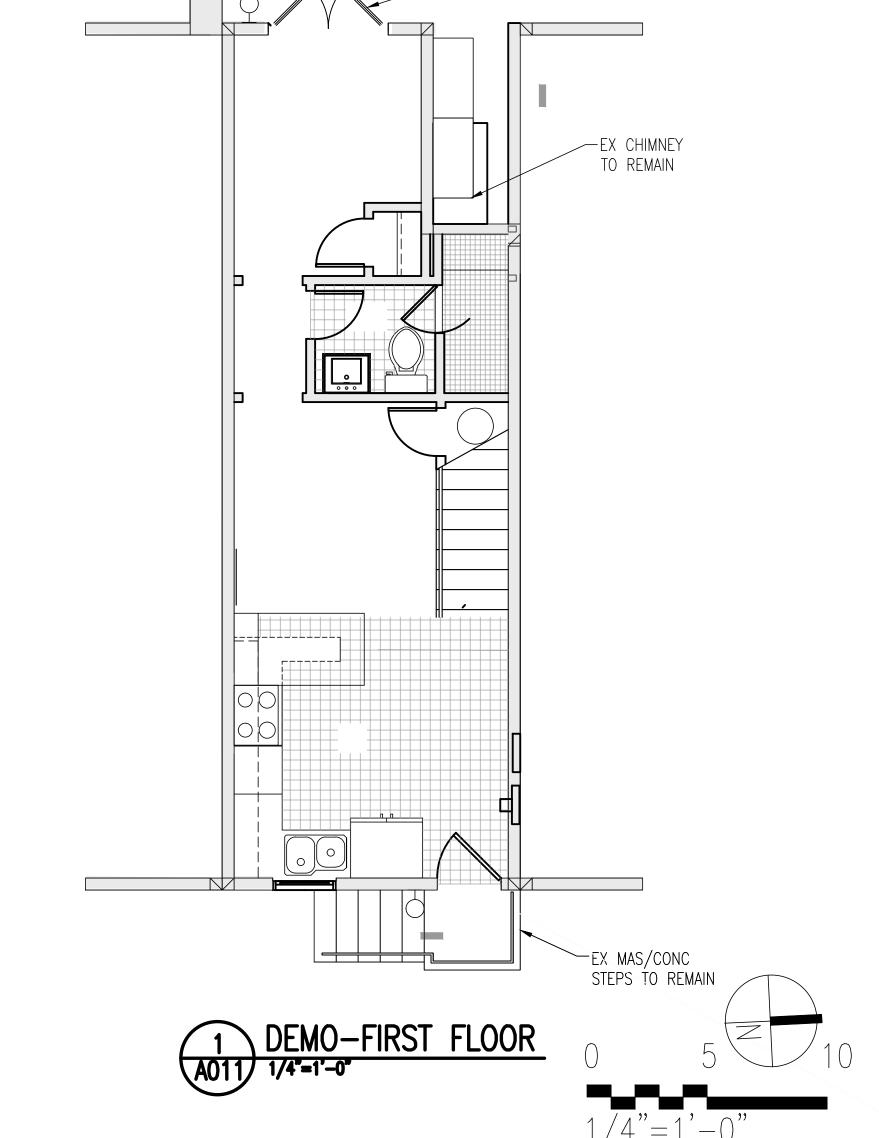

—DEMO EX DOORS

Renovations to 1436 36th St NW Washington DC. 20007

Drawing Title

DEMOLITION

FIRST FLOOR


SECOND FLOOR

ROOF


GU ID 2-D32-01

Project No. VA2205-01

Date
08 FEB 2023

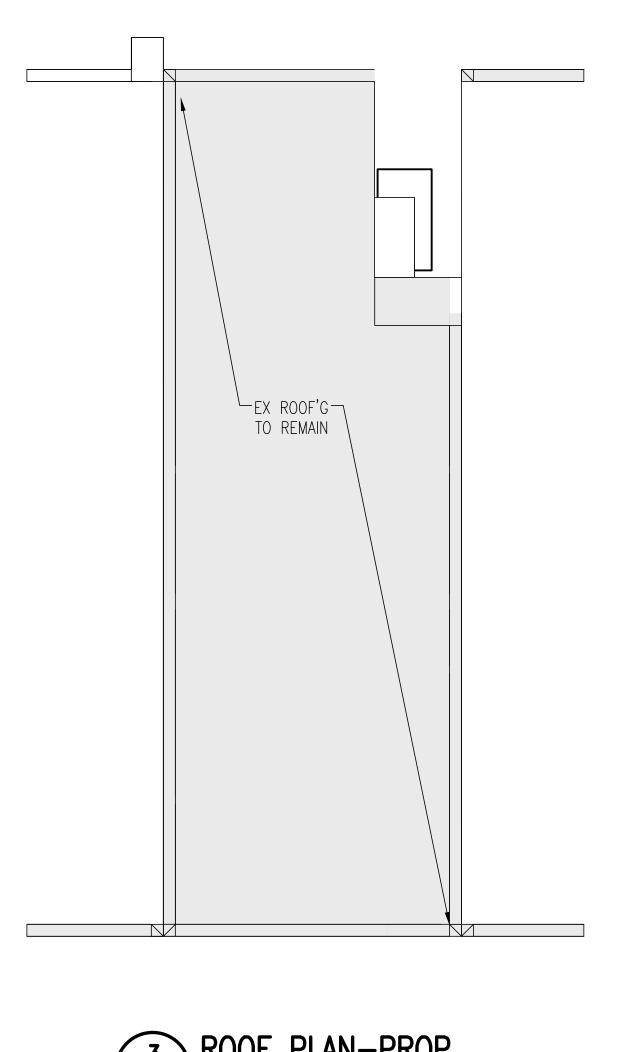




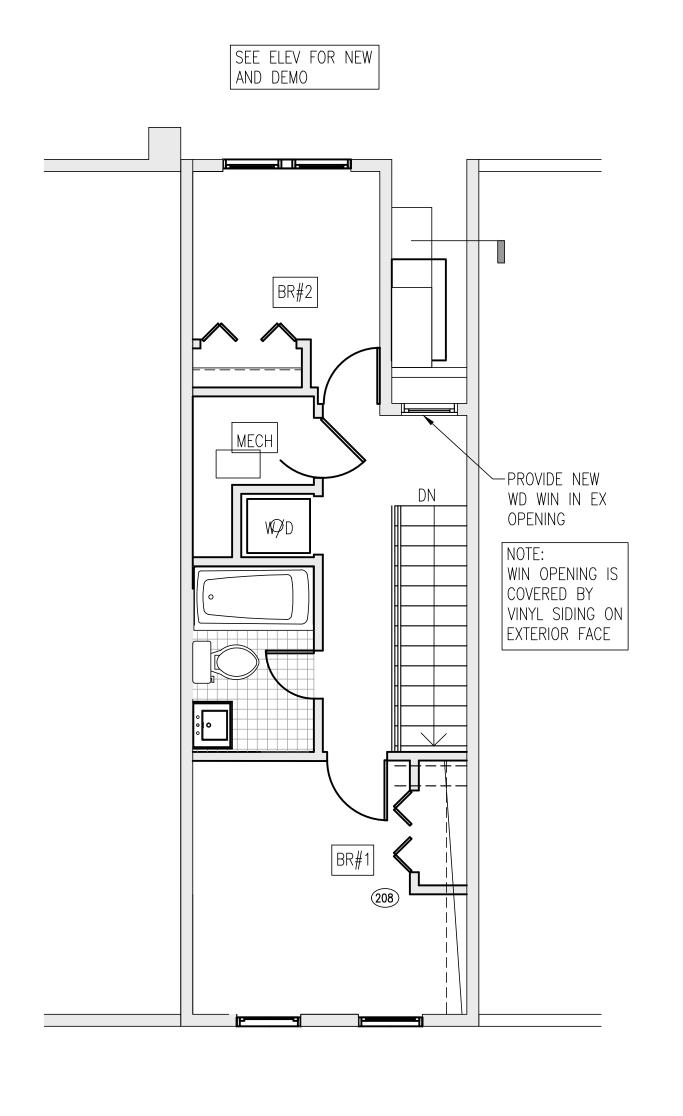

SEE ELEV FOR NEW AND DEMO

SECOND FLOOR PLAN-PROP

A021 1/4"=1"-0"

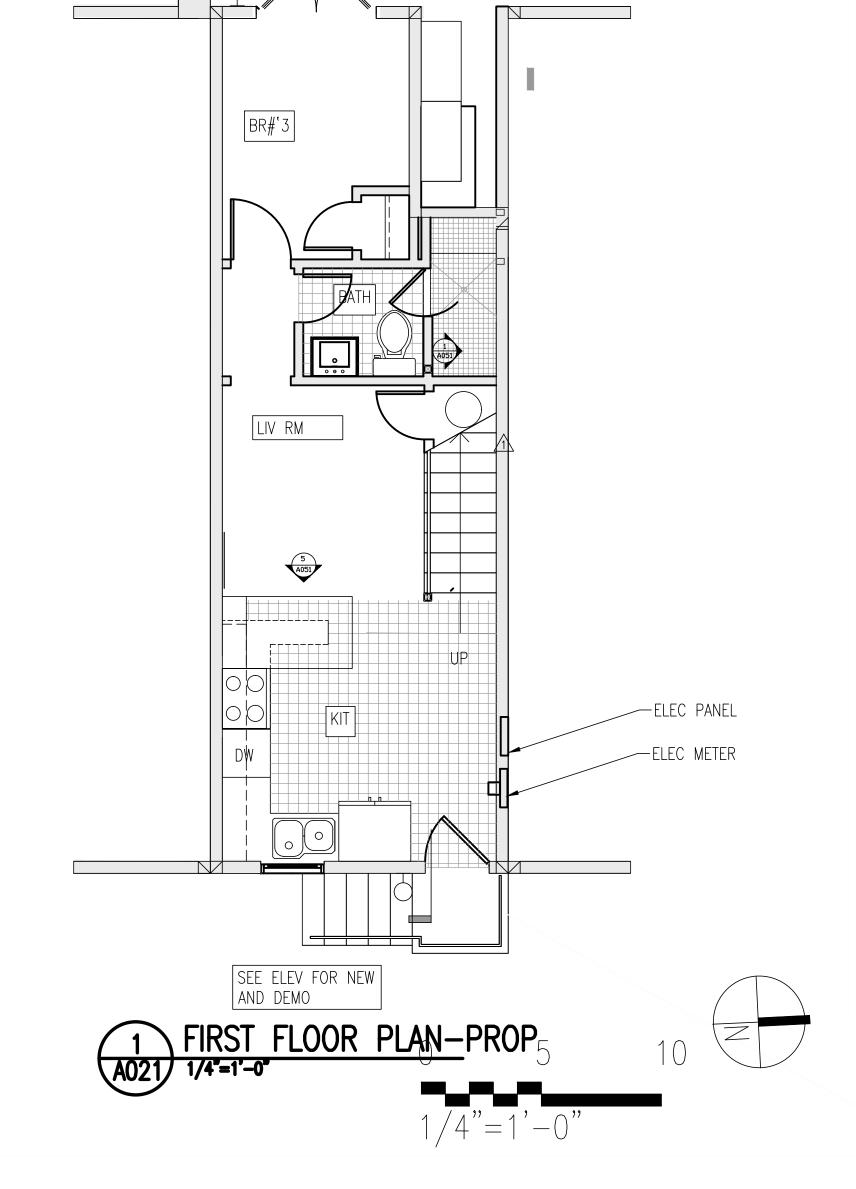

SEE ELEV FOR NEW AND DEMO

Renovations to
1436 36th St
NW
Washington DC

Washington DC. 20007

—PROIVDE NEW EXT DOORS

Drawing Title

EX FLR PLANS

FIRST FLOOR
SECOND FLOOR
ROOF

GU ID 2-D32-01

Project No.

VA2205-01

08 FEB 2023